CITY OF BALTIMORE DEPARTMENT OF GENERAL SERVICES DESIGN AND CONSTRUCTION DIVISION



CONTRACT NO. G5 21822

LOWER PARK HEIGHTS COMMUNITY CENTER ROOF REPLACEMENT/WALL REPAIR/ENTRY BID DOCUMENTS

3939 REISTERSTOWN RD. BALTIMORE, MD 21215

FOR THE MAYOR AND CITY COUNCIL BRANDON M. SCOTT, MAYOR

	REVISIONS						
No.	DATE DESCRIPTION						
8/03/2022							
TITLE SHEET							

CONSULTANTS



PROFESSIONAL CERTIFICATION

USER AGENCY **USER AGENCY NAME**

BALTIMORE FIRE DEPARTMENT

DEPARTMENT OF **GENERAL SERVICES** 200 HOLLIDAY ST. BALTIMORE, MD 21202

(410) 545-6071

Husam Albattrawi

PROJECT MANAGER

DESIGN SECTION

06/27/2023

RobertMooney

CONSTRUCTION MANAGER

CONSTRUCTION SECTION

06/28/2023

SECTION CHIEF


DESIGN SECTION

Signed on behalf of Divisior Chief: Marwan Al Karajat DIVISION CHIEF,

DESIGN & CONSTRUCTION DIVISION

G-000

DEPARTMENT OF GENERAL SERVICES

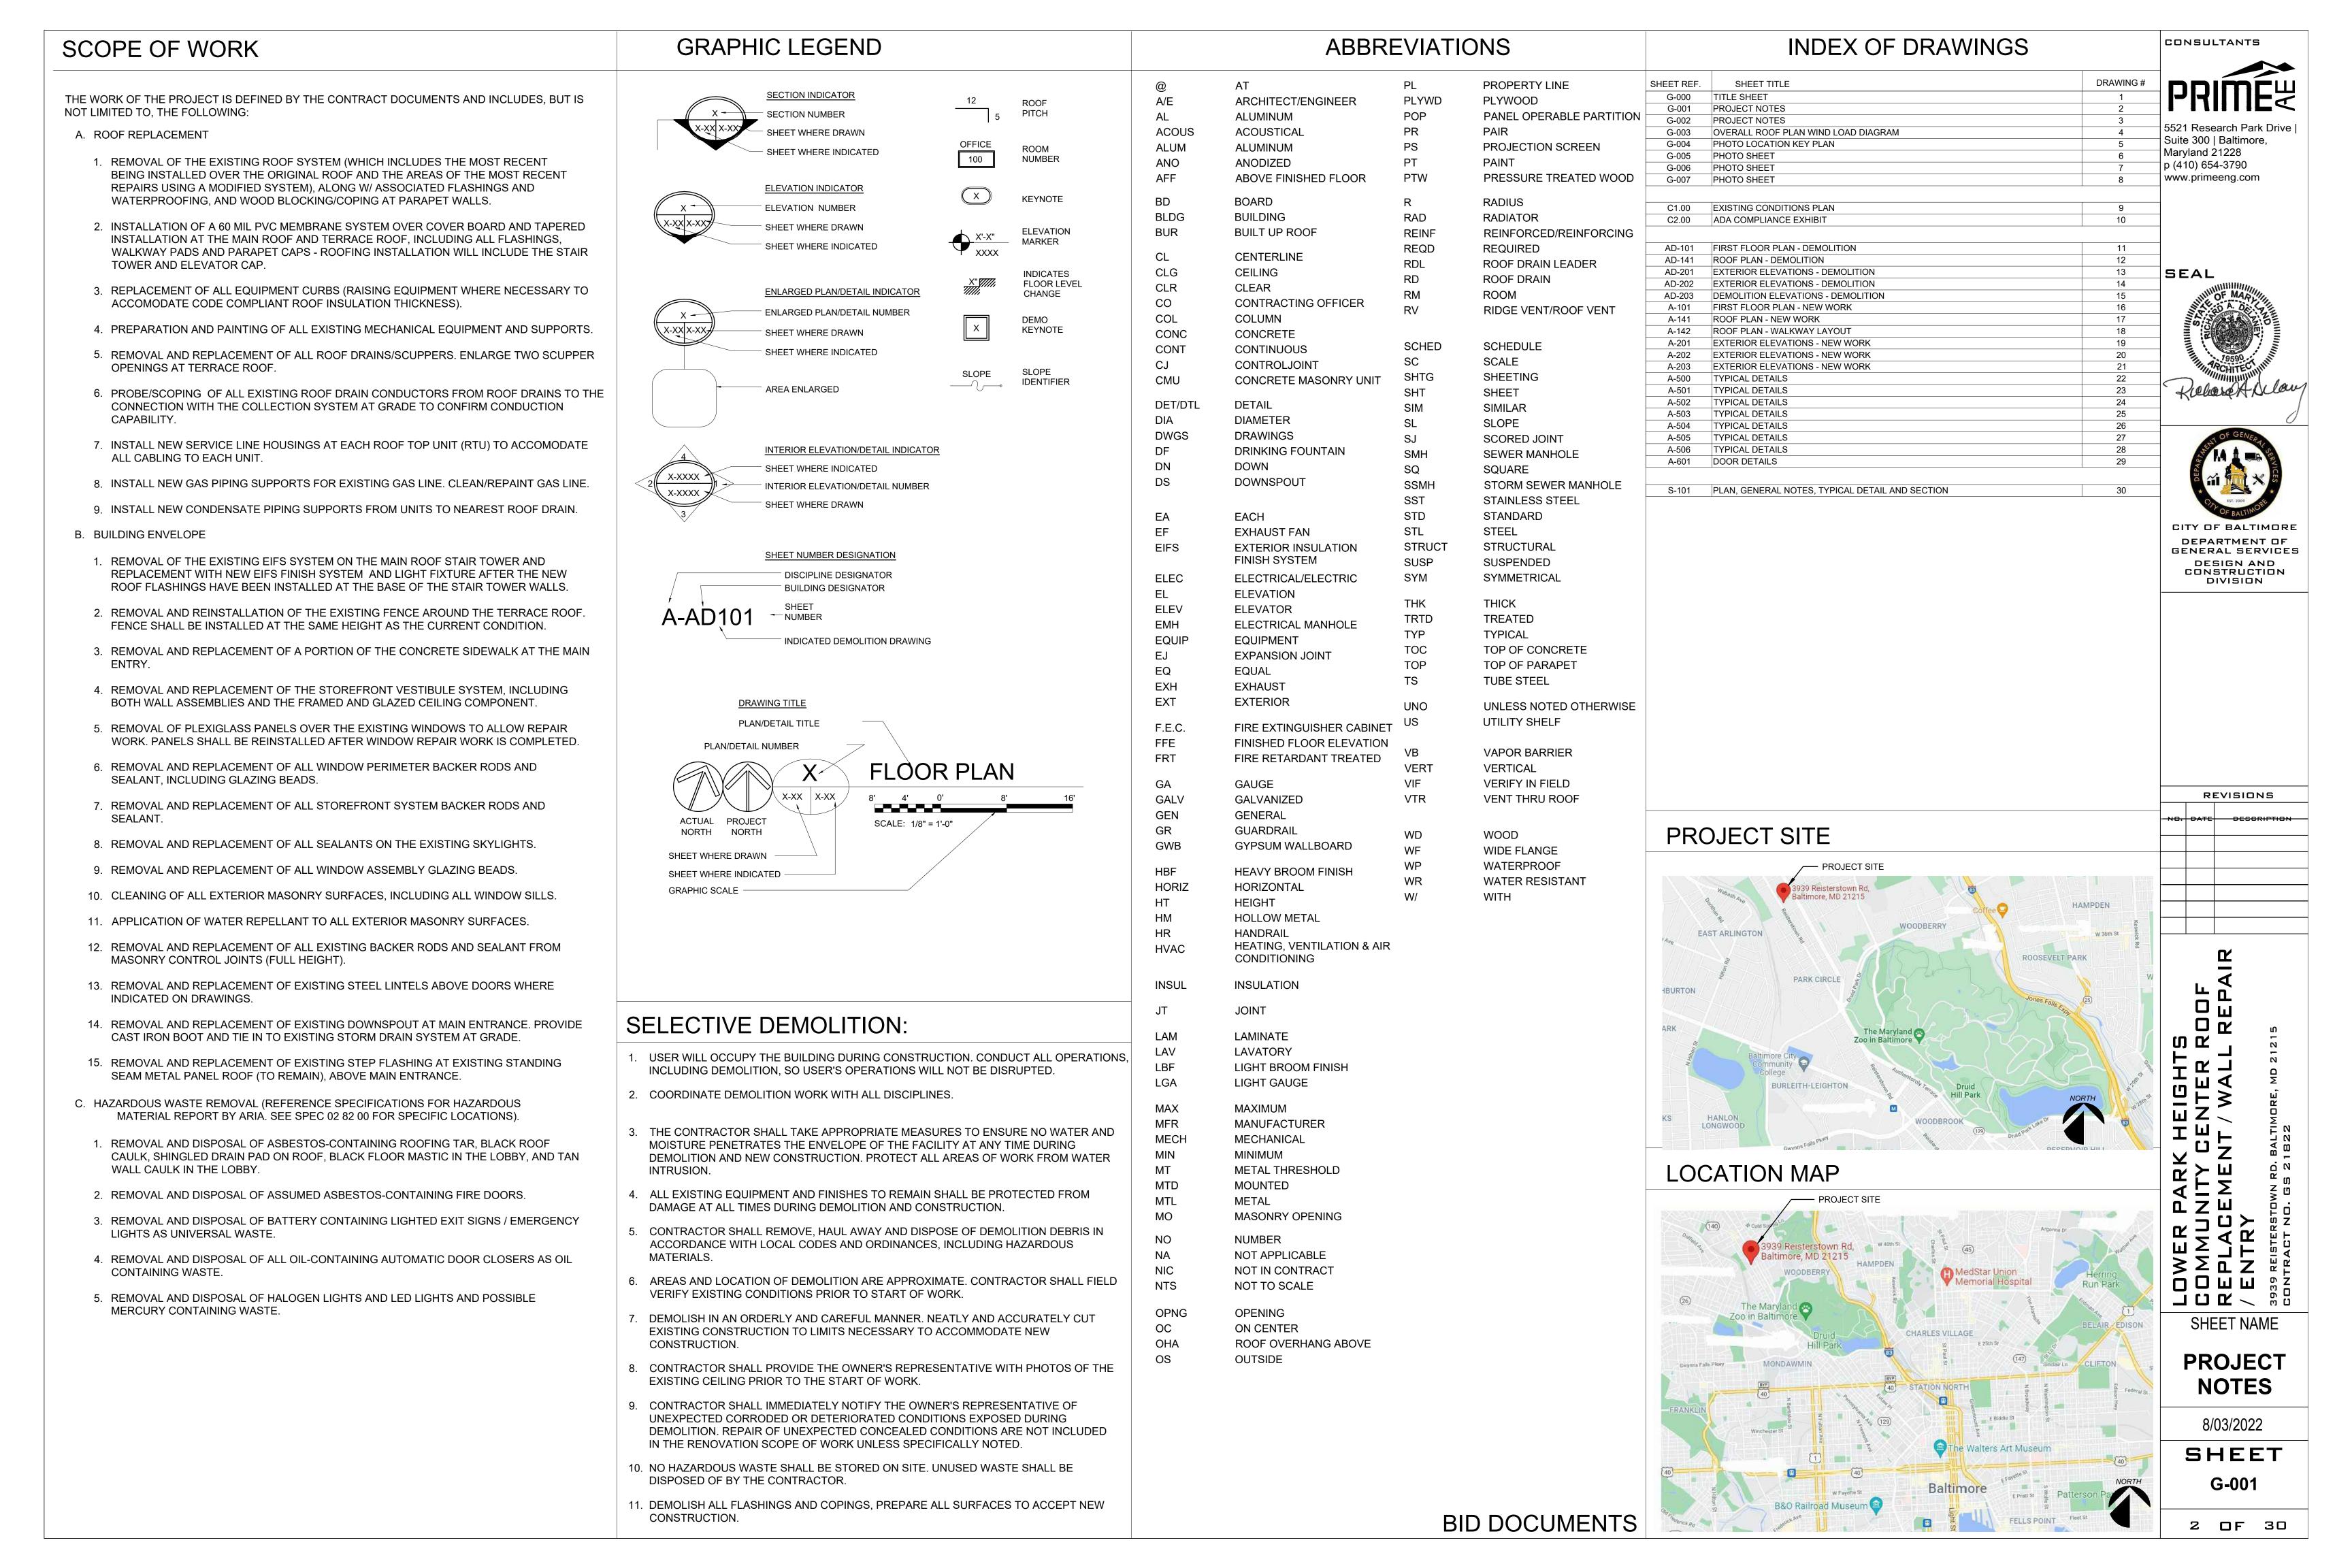


- MANY OF THE DETAILS CONTAINED HERE-IN ARE DEVELOPED BASED UPON DESIGN PERFORMANCE CRITERIA. MANY DETAILS ARE GENERIC IN NATURE AND DEPENDANT ON THE ACTUAL PRODUCT SELECTION MADE BY THE CONTRACTOR DURING BIDDING AND CONSTRUCTION. WHEN REQUESTED OR REQUIRED BY THE MANUFACTURER DUE TO THE CONFIGURATION OF THEIR PRODUCT(S), MINOR VARIATIONS FROM THE DETAILS SHOWN WILL BE CONSIDERED WHEN THEY MEET THE REQUIREMENTS OF THE CONTRACT DRAWINGS AND SPECIFICATIONS. THE ARCHITECT WILL DETERMINE THE EQUIVALENCY OF ANY SUCH VARIATION. THE CONTRACTOR WILL SUBMIT AS A MINIMUM THE DETAILS SHOWN WITH ANY VARIATION TO THE DETAILS CONTAINED IN THE CONTRACT DOCUMENTS. IF PROPOSED VARIATIONS TO THE DETAILS ARE NOT ACCEPTED, THE CONTRACTOR WILL EITHER INSTALL THE MATERIAL AS INDICATED ON THE CONTRACT DRAWINGS AND SPECIFICATIONS OR REVISE THE PROPOSED DETAILS AS DIRECTED BY THE ARCHITECT.
- 2. IF THE CONTRACTOR ENCOUNTERS ANY UNFORESEEN SITE CONDITIONS DURING THE PERFORMANCE OF THE CONTRACT, INCLUDING BUT NOT LIMITED TO SUSPECTED ASBESTOS CONTAINING MATERIAL (ACM) OR LEAD-BASED PAINT, THE CONTRACTOR SHALL CEASE EXECUTION OF WORK/OPERATIONS IN THE SUSPECT AREA, IMMEDIATELY EVACUATE ALL PERSONNEL AND NOTIFY THE OWNER'S REPRESENTATIVE. VERIFICATION OF THE SUSPECT MATERIAL WILL COMMENCE THROUGH SAMPLE AND ANALYSIS BY A CONTRACTOR QUALIFIED FOR, SUCH AS DIRECTED.
- 3. AT THE COMPLETION OF CONSTRUCTION, CONTRACTOR SHALL RESTORE STAGING AREAS, GRASS AND OTHER DISTURBED LANDSCAPING AFFECTED BY CONSTRUCTION, LAY DOWN AND STAGING ACTIVITIES TO ORIGINAL CONSTRUCTION.
- 4. DO NOT SCALE DRAWINGS. IF DIMENSIONS ARE IN QUESTION CONTACT THE ARCHITECT.
- 5. PROVIDE SAFETY FENCE AROUND MATERIAL STORAGE AREA.
- 6. COORDINATE WITH OWNER'S REPRESENTATIVE FOR STAGING AND CONTRACTOR PARKING AREAS.
- CONTRACTOR SHALL PROVIDE COMPLETE AS-BUILT INFORMATION AS PART OF THE PROJECT CLOSE-OUT SUBMITTAL.
- 8. WHERE ROOFING AND FLASHING DETAILS ARE NOT PROVIDED THE CONTRACTOR WILL PROVIDE DETAILS UTILIZING SMACNA AND NRCA AS MINIMUM STANDARDS FOR DEVELOPMENT OF THE DETAIL; HOWEVER IN ALL CASES ALL SYSTEMS MUST MEET CURRENT CODES.
- 9. CONTRACTOR WILL COORDINATE ALL ACTIVITIES THAT GENERATE NOXIOUS ODORS OR EXCESSIVE NOISE WITH CONTRACTING OFFICER'S REPRESENTATIVE. MINIMIZE THE NEGATIVE EFFECTS OF FUMES AND
- 10. ALL FASTENERS TO BE HOT DIPPED GALV. (MINIMUM G185) OR STAINLESS STEEL UNLESS OTHERWISE SPECIFICALLY NOTED (PROPERLY COATED FASTENERS WILL BE CONSIDERED WHEN NOT IN CONTACT WITH PRESERVED TREATED WOOD).
- 11. SECURE CONSTRUCTION LOCATIONS AT ALL TIMES.
- 12. IN NO CASE WILL LENGTHS OF FLASHING UNDER 20 INCHES BE ALLOWED. IN ALL CASES FASTENERS WILL BE PLACED STARTING WITHIN 2 INCHES OF THE EDGE OF EACH PIECE OF FLASHING.
- 13. THE CONTRACTOR WILL MAINTAIN A CLEAN, SAFE AND SECURE SITE AND PROVIDE DAILY CLEAN UP.
- 14. THE BUILDING MAY BE FULLY OCCUPIED THROUGHOUT THE DURATION OF CONSTRUCTION. THE CONTRACTOR WILL PROVIDE SAFETY FENCING & OTHER SAFETY MEASURES AS REQUIRED TO PROTECT THE OCCUPANTS & VISITORS TO THE BUILDINGS. THE CONTRACTOR MAINTAINS THE SOLE RESPONSIBILITY & LIABILITY FOR IMPLEMENTATION, DESIGN & MAINTENANCE OF ALL SAFETY FEATURES, INCLUDING BARRICADES, COVERED WALKWAYS & FENCES.
- 15. CONTRACTOR WILL DRY-IN WEATHER TIGHT ALL AREAS OF WORK DAILY IN ORDER TO PROTECT THE EXISTING FACILITY & EQUIPMENT. MAINTAIN A SECURE AND WATERTIGHT FACILITY THROUGHOUT
- 16. CONTRACTOR ASSUMES FINANCIAL RESPONSIBILITY FOR ALL DAMAGE AS A RESULT OF LEAKS/WATER INTRUSION FROM CONSTRUCTION ACTIVITIES.
- 17. SHOP DRAWINGS PRODUCED FOR THIS PROJECT WILL INCLUDE PRODUCT DATA & INSTRUCTIONS FOR INSTALLATION OF ALL FASTENERS, AS WELL AS FASTENER SPACING, PULL OUT DATA, DIAMETER EMBEDMENT & MATERIAL. DEVELOP SHOP DRAWINGS FOR ALL FASTENER CONDITIONS AND SUBMIT FOR REVIEW. ANY INSTALLATION PRIOR TO THE RECEIPT OF APPROVED SHOP DRAWINGS IS AT THE SOLE RISK OF THE CONTRACTOR.
- 18. ALL FLASHINGS SHALL BE DESIGNED TO WITHSTAND THE WIND LOADS INDICATED ON THE DRAWINGS.
- 19. CONTRACTOR SHALL LIMIT ROOF LOADING TO THE MAXIMUM EXTENT POSSIBLE. MAX LOAD OF CONSTRUCTION MATERIALS NOT TO EXCEED A 20 PSF LIVE LOAD.
- 20. CONTRACTOR SHALL VERIFY ALL EXISTING CONDITIONS PRIOR TO DEVELOPMENT OF SHOP DRAWINGS AND CONSTRUCTION. INVESTIGATION PRIOR TO SHOP DRAWINGS INCLUDES, BUT IS NOT LIMITED TO: VERIFCATION OF ROOF SLOPES, DECK CONDITION ASSESSMENT, FIELD MEASUREMENTS, PARAPET HEIGHT ADJUSTMENT VERIFICATION, FASTENER PULL TESTS, DRAIN BOWL CONDITION ASSESSMENT SUBMIT FINDINGS REPORT TO ARCHITECT; IDENTIFY ALL FINDINGS AND DISCREPANCIES.
- 21. THE CONTRACTOR IS SOLELY RESPONSIBLE FOR THE SAFE USE OF PRODUCTS ON THE SITE. THE CONTRACTOR IS RESPONSIBLE FOR ALL MEANS AND METHODS TO PRODUCE THE WORK INCLUDING ALL SAFETY MEASURES TO PROTECT HIS STAFF AND FACILITY OCCUPANTS. THE CONTRACTOR WILL FURNISH TO THE CONTRACTING OFFICER MSDS SHEETS ON MATERIAL KNOWN OR THAT MIGHT BE CONSIDERED NOXIOUS OR HAZARDOUS TO BE USED IN THE CONSTRUCTION WORK. THE PROJECT MAY INCLUDE THE REQUIREMENT TO PROVIDE DUST AND FUME CONTROL MEASURES. THESE MEASURES AND THEIR EFFECTIVENESS ARE SOLELY UNDER THE CONTROL OF THE CONTRACTOR.
- 22. ALL DIMENSIONS DEPICTED IN THE CONTRACT DOCUMENTS ARE TO BE CONSIDERED APPROXIMATE AND ARE GIVEN FOR PRICING PURPOSES ONLY: THE DIMENSIONS DEPICTED ARE NOT TO BE CONSIDERED "ACTUAL" FOR MANUFACTURING PURPOSES. DUE TO THE NATURE OF RENOVATING EXISTING CONDITIONS, IT IS THE CONTRACTOR'S RESPONSIBILITY TO FIELD VERIFY ALL CONDITIONS AND REQUIREMENTS, WHERE WORK IS TO BE EXECUTED, PRIOR TO THE COMMENCEMENT OF WORK; FIELD VERIFICATION SHALL BE REQUIRED FOR ANY DEMOLITION OF EXISTING CONDITIONS, AS WELL AS, BEFORE ORDERING MATERIALS AND INSTALLATION OF PRODUCT.

- 23. WHEN CONDUCTING DECK REPLACEMENT WORK AT THE ROOF HATCH, THE CONTRACTOR SHALL: PERFORM DAILY CLEAN UP.
- COORDINATE ACTIVITIES WITH THE BUILDING OCCUPANT/USER SO AS TO MINIMIZE DISRUPTION OF ON-GOING ACTIVITIES.
- SCHEDULE ACTIVITIES TO MAXIMIZE OFF DUTY WORK HOURS AND/OR TIMES THE BUILDING IS NOT OCCUPIED.
- PROVIDE 48 HOUR ADVANCE NOTICE IN WRITING REQUESTING PERMISSION FOR OFF HOUR WORK. PROVIDE FULL-TIME (INTERIOR) SAFETY OBSERVER DURING ALL TIMES WHERE THE ROOF DECK IS OPEN TO THE INTERIOR.
- 24. WORK OCCURRING IN OR ABOVE OCCUPIED AREAS IS REQUIRED. AREAS BELOW DECK TO BE REPLACED WILL BE VACATED BY PERSONNEL DURING THE DURATION OF THE DECK REPLACEMENT. PROTECT EQUIPMENT TO REMAIN. PROVIDE DAILY CLEANUP AND PROTECTIONS. AVOID ACTIVITIES ON THE ROOF THAT CAUSE DUST AND DEBRIS FROM FALLING ONTO UNPROTECTED PERSONNEL OR EQUIPMENT. PROVIDE TEMPORARY DRY IN CONCURRENT WITH ROOF DECK REPLACEMENT AND DEMOLITION OF EXISTING ROOFING SYSTEM. PROVIDE DUST AND DEBRIS PROTECTION AS REQUIRED THROUGHOUT THE CONSTRUCTION PERIOD. PROVIDE SAFETY MONITORS AS NEEDED TO PROTECT OCCUPANTS DURING

STRUCTURAL REPAIR OR ROOFING WORK. PROVIDE SAFETY FENCES AND BARRIERS AS NEEDED.

- 25. THE CONTRACTOR WILL PROVIDE A PHASING PLAN THAT DESCRIBES ALL ACTIVITIES RELATED TO LIFE SAFETY, DUST PROTECTION, AS WELL AS REQUIRED ACTIVITIES TO MAINTAIN THE FACILITY IN A WATER-TIGHT CONDITION. THE CONTRACTOR WILL PROVIDE AS A PART OF HIS SCHEDULE A DETAILED PHASING PLAN DESCRIBING IN DETAIL THE ACTIVITIES AND SEQUENCES REQUIRED. MINIMUM REQUIREMENTS INCLUDE PERSONNEL RESPONSIBLE FOR IMPLEMENTATION; MATERIALS TO BE USED; APPROACH TO WATERPROOFING AND DUST PROTECTION: APPROACH TO PROTECTING OCCUPANTS, FURNISHINGS AND EQUIPMENT; INFORMATION ON ANY TEMPORARY CONSTRUCTION; AND THE SEQUENCE TIED TO DEMOLITION AND NEW WORK. INCLUDE SHOP DRAWINGS AND SUPPLEMENTAL SKETCHED TO DESCRIBED ALL ACTIVITIES AND INSTALLATIONS. THE CONTRACTOR REMAINS SOLELY RESPONSIBLE FOR THE MEANS AND METHODS TO BE USED FOR PROTECTION OF WORK TO REMAIN AS WELL AS PERSONNEL, EQUIPMENT AND FURNISHINGS. THE PHASING PLAN WILL BE KEPT CURRENT THROUGHOUT THE PROJECT; PRESENT AND REVIEW THE UPDATED PLAN AT EACH PROJECT MEETING.
- 26. CONTRACTOR SHALL MINIMIZE THE IMPACT OF CONSTRUCTION ACTIVITY ON ONGOING OPERATIONS. THE CONTRACTOR IS RESPONSIBLE FOR COORDINATING ALL INTERIOR WORK WITH OWNER'S REPRESENTATIVE. COORDINATE ALL ACTIVITIES AT EACH PROJECT MEETING. IDENTIFY ANY POTENTIAL DISRUPTION TO ONGOING OPERATIONS; WRITTEN APPROVAL IS REQUIRED FOR ALL DISRUPTIONS. IDENTIFY ACCESS AREAS, POTENTIALLY DISTURBING NOISE AND/OR FUMES, WORK TIMES, DATES AND DURATIONS. PROVIDE ALTERNATIVE METHODS AND TIMES TO COMPLETE THE WORK AS NEEDED TO AVOID DISRUPTION TO ONGOING ACTIVITIES. PROVIDE WRITTEN DOCUMENTATION OF DISCUSSION HELD IN MEETINGS.

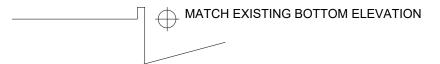

- 27. ROOF DRAINS: PROVIDE NEW CLAMPING RING AND SCREWS (BRASS OR SST). PROVIDE EXTENSION RINGS TO ALLOW FOR REQUIRED INSULATION. FASTEN EACH LAYER OF SOLID WOOD BLOCKING AT 12" STAGGERED - MIN. 16P NAILS. ADJUST ROOF DRAIN SUMP SIZES AND VALLEY SLOPE LINES TO PROVIDE CLEAR DRAINAGE TO ROOF DRAINS. REFER TO DETAIL 1/A500.
- 28. NEW WOOD BLOCKING AT THE COPING IS TO BE SECURED AS DESCRIBED BELOW EXCEPT WHERE MORE STRINGENT REQUIREMENTS ARE INDICATED IN THE DETAILS.

PERIMETER BLOCKING TO RESIST 200 LBS OF VERTICAL FORCE (PCF)

MINIMUM BLOCKING SIZE IS 2x6 FASTENERS SHALL BE LOCATED WITHIN 3" OF EACH END OF THE BLOCKING WITH COUNTERSUNK HEADS, WHEN MASONRY BLOCK IS CAST WITH LIGHT WEIGHT AGGREGATE, ANCHOR BOLTS (WEDGE TYPE OR EPOXY SET) SHOULD:

BE 1/2" DIAMETER, EMBEDDED 8" MIN. DEPTH. SPACE BOLTS AT 2' O.C. STAGGERED WITHIN 8' OF CORNERS. FASTEN EACH LAYER OF SOLID WOOD BLOCKING AT 12" STAGGERED - MIN. 16P NAILS.

29. PROVIDE MINIMUM 1/4" PER FOOT POSITIVE SLOPE AT ALL CRICKETS.


PAINT NOTES (METALS)


COATING FOR METALS AND RUSTED STEEL DECKS:

BASIS OF DESIGN: MASTER PAINT INSTITUTE MPI 20 - SHERWIN WILLIAMS - ZINC CLAD IV; A TWO-COMPONENT. POLYAMIDE EPOXY, ZINC RICH COATING. MINIMUM 4 MIL DRY MIL PER COAT. APPLY 1 COAT AT RUSTED / CORRODED METAL DECKS. ZINC CLAD® IV CONTAINS 85%, BY WEIGHT, OF ZINC DUST PIGMENT IN THE DRIED FILM. PREPARE DECK SURFACE TO SSPC-SP 2 OR 3. APPLY IN STRICT ACCORDANCE WITH MANUFACTURER'S WRITTEN INSTRUCTION.

NOTE: CONTRACTOR HAS THE OPTION TO USE "KEM KROMIC" (SHERWIN WILLIAMS) ON EXISTING CORRODED METAL DECKS.


JOINT DIAGRAMS

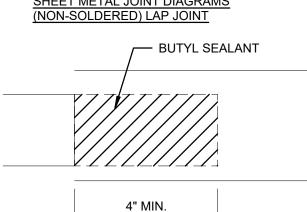

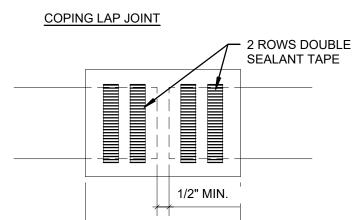

8" MIN.



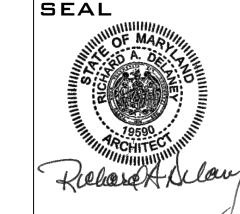

CONSULTANTS

5521 Research Park Drive

Suite 300 | Baltimore,

Maryland 21228

p (410) 654-3790

www.primeeng.com



DEPARTMENT OF GENERAL SERVICES DESIGN AND CONSTRUCTION DIVISION

REVISIONS NO. DATE DESCRIPTION

S C


_ ט ע / SHEET NAME

PROJECT NOTES

8/03/2022

SHEET G-002

BID DOCUMENTS

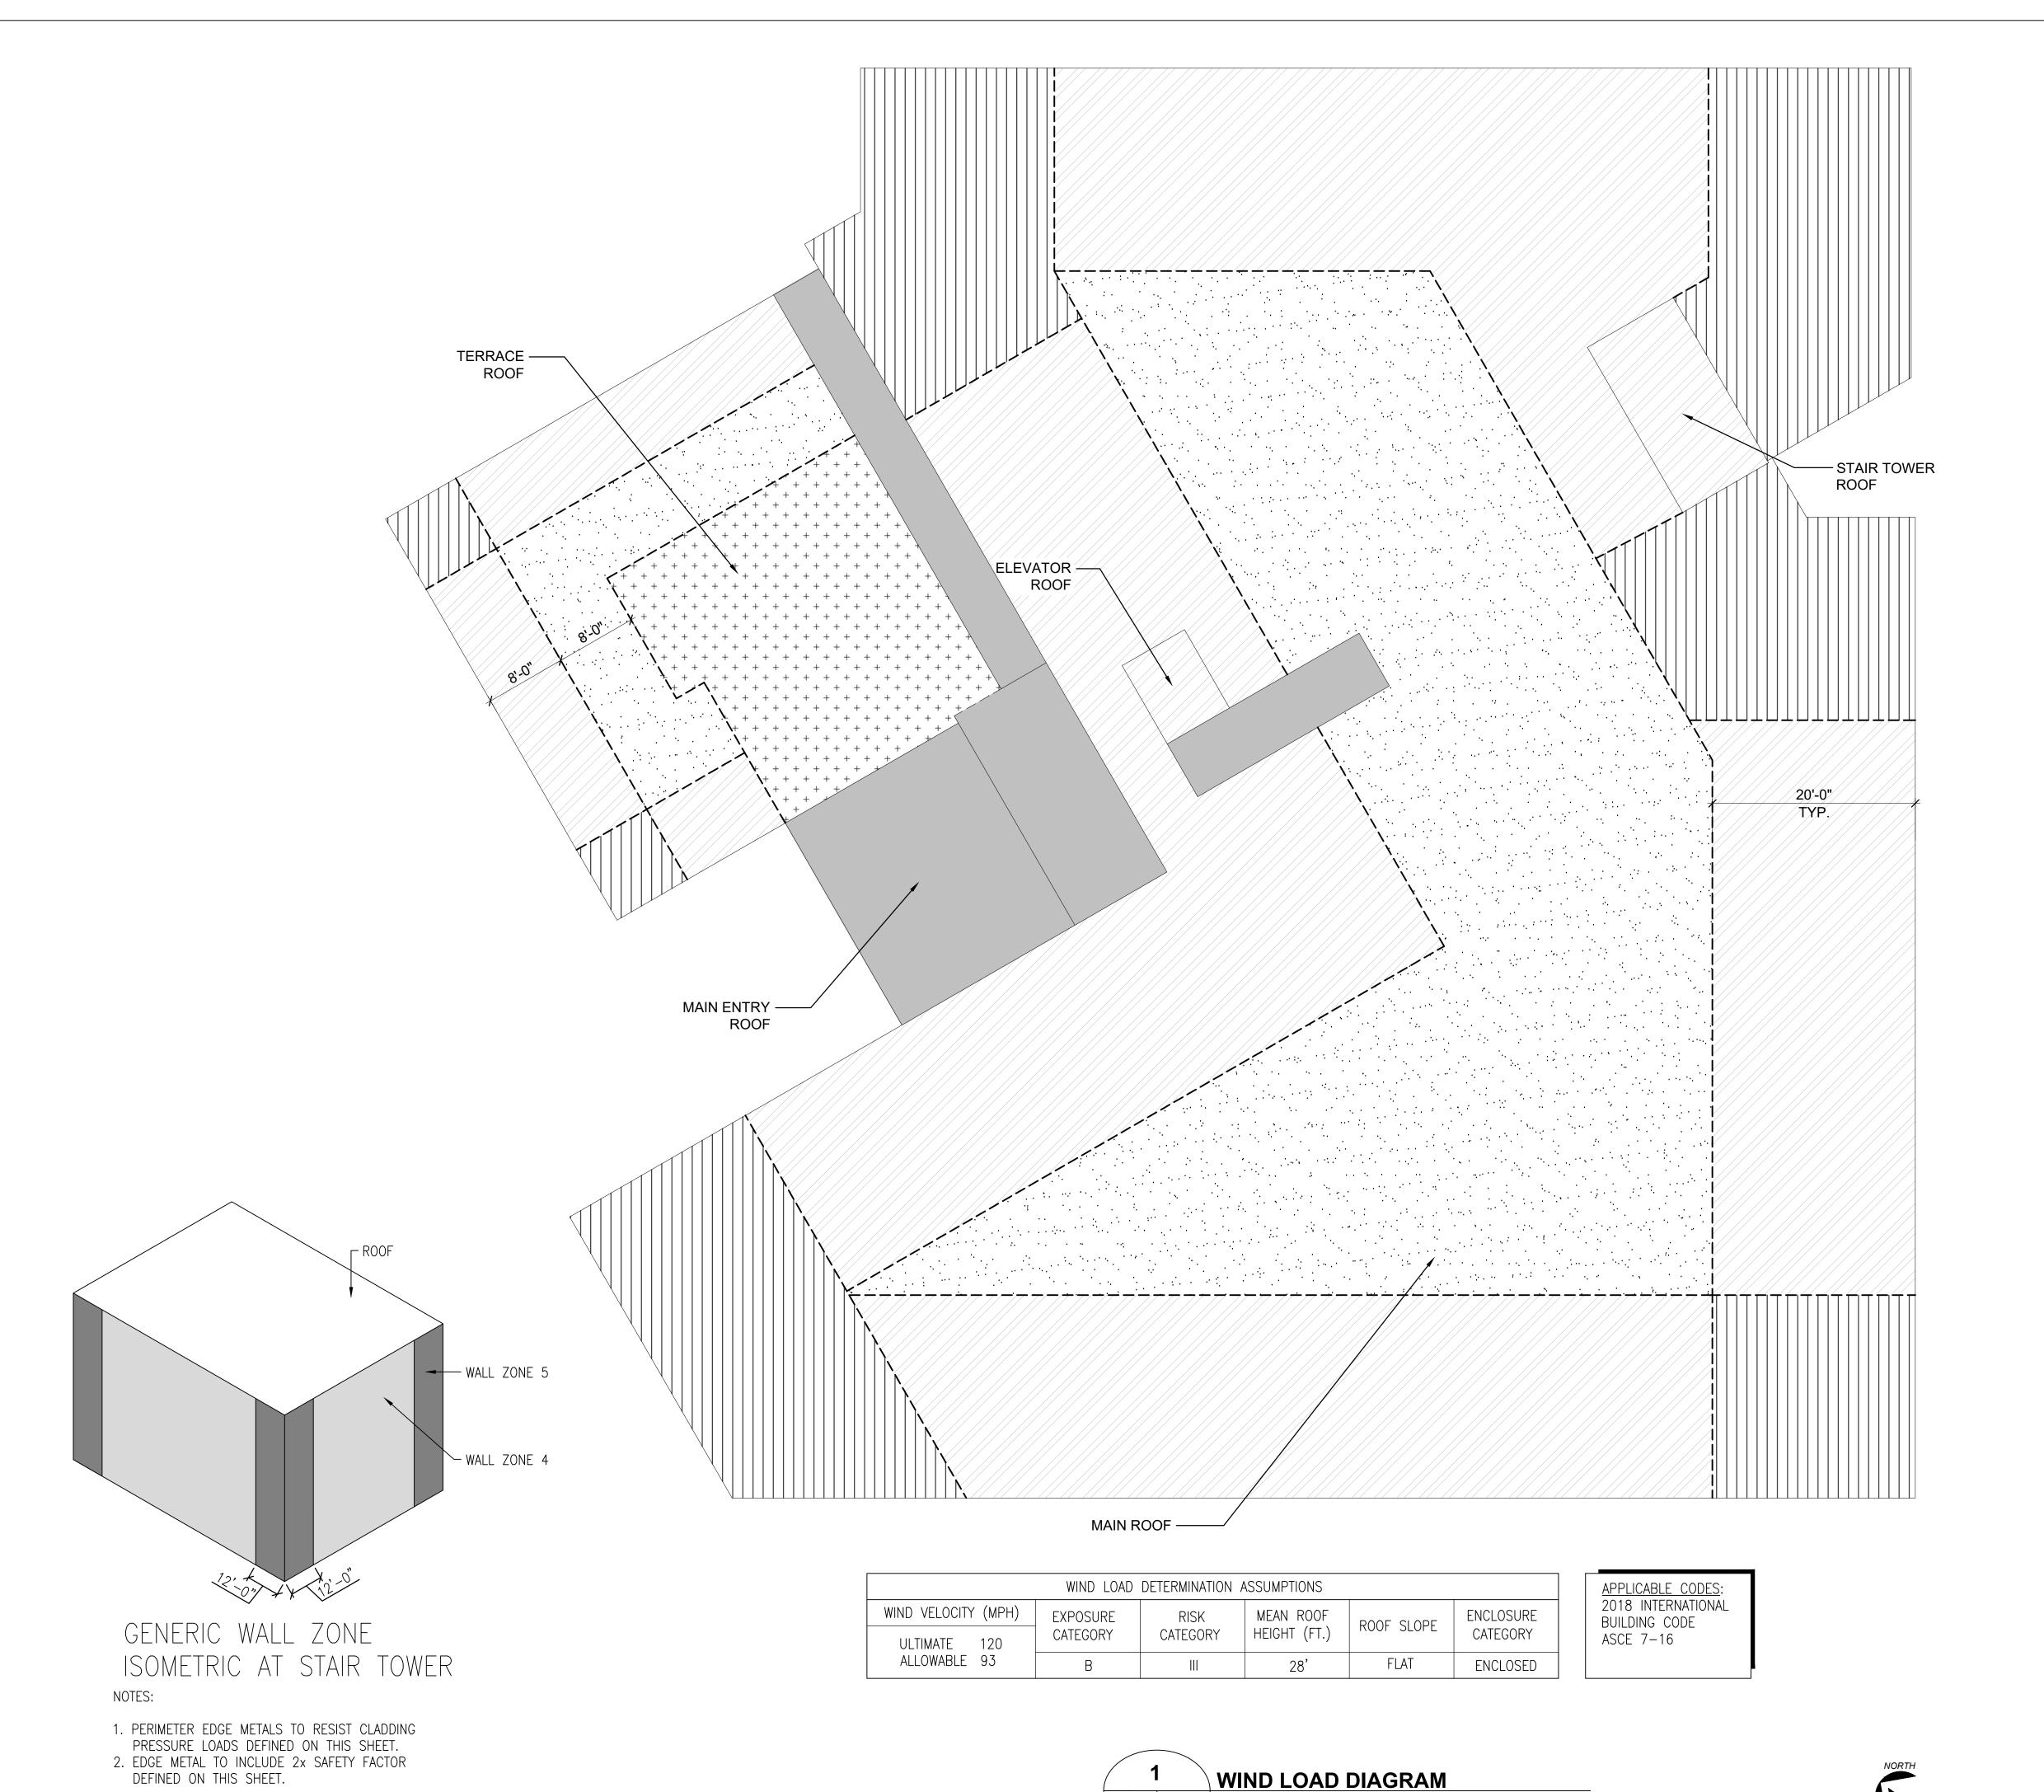


SCALE: 1/8" = 1'-0"

WIND LOADS

AT A MINIMUM USE UPLIFT LOADS SHOWN. LOADS INCLUDE A 2x SAFETY FACTOR ADDED TO ASF LOADS.

ZONE	PRESSURE(PSF)		
1'	-29		
1	-50		
2	-66		
3	-89		
4	-34		
5	-42		

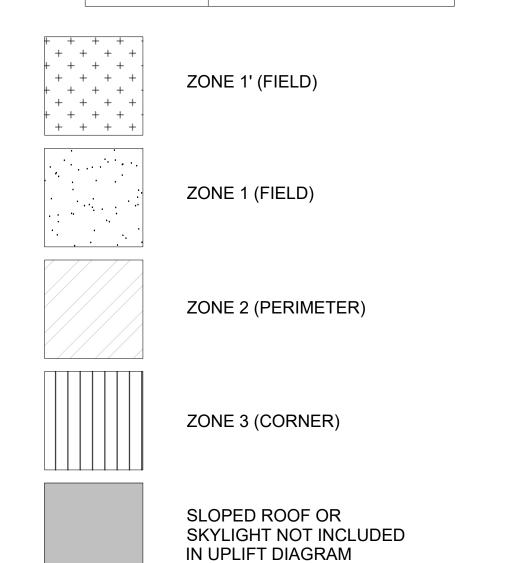



CONSULTANTS

5521 Research Park Drive

Suite 300 | Baltimore,

Maryland 21228 p (410) 654-3790 www.primeeng.com

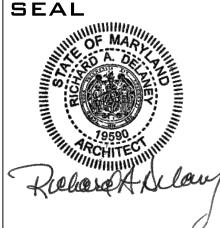

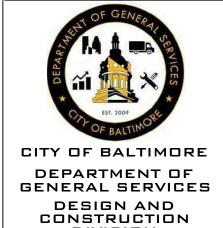

DIVISION

	REVISIONS							
	DATE DESCRIPTION							
-	1							


COMMUNITY CENTER ROOF
REPLACEMENT / WALL REPAI
F ENTRY
S939 REISTERSTOWN RD. BALTIMORE, MD 21215
CONTRACT NO. GS 21822


SHEET NAME

ROOF PLAN WIND LOAD **DIAGRAM**

8/03/2022

SHEET G-003

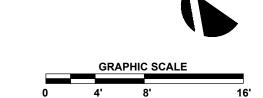


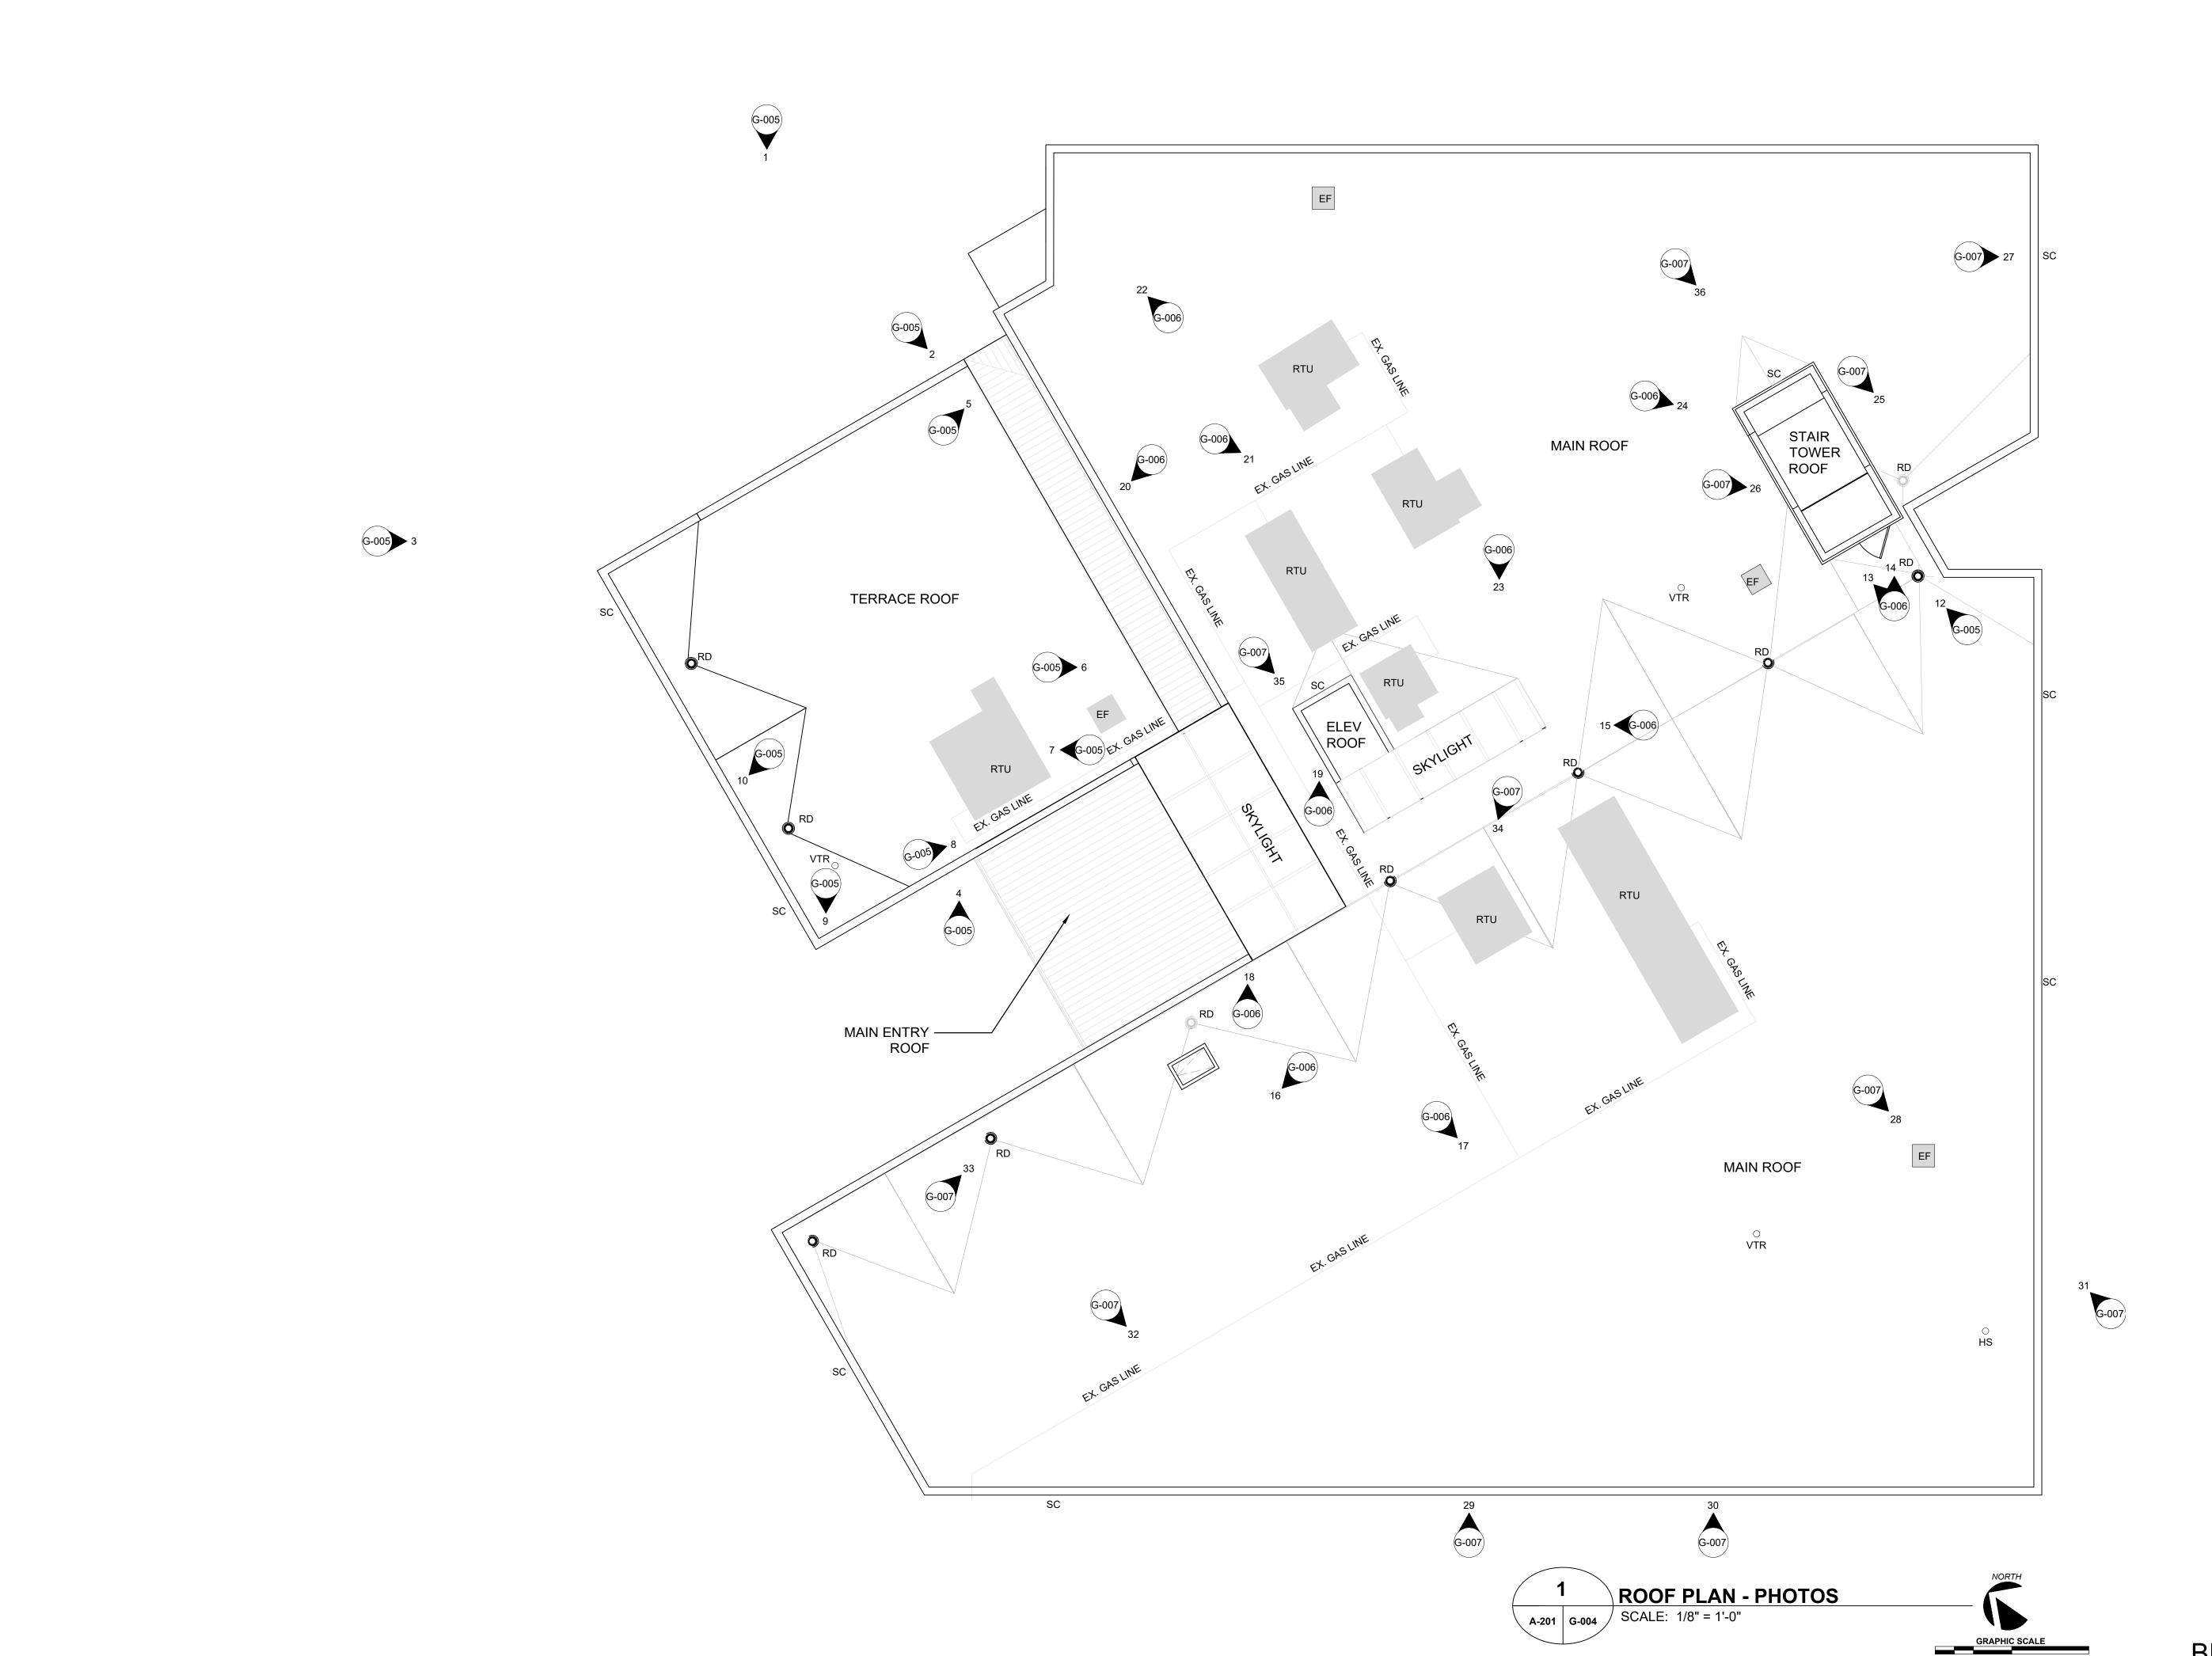



5521 Research Park Drive | Suite 300 | Baltimore, Maryland 21228 p (410) 654-3790 www.primeeng.com

SEAL

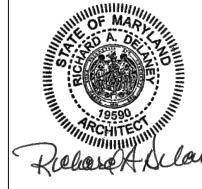



OF BALTIMORE

DEPARTMENT OF

GENERAL SERVICES

DESIGN AND

CONSTRUCTION

DIVISION

REVISIONS

NO. DATE DESCRIPTION

COMMUNITY CENTER ROOF

REPLACEMENT / WALL REPAIR

/ ENTRY

3939 REISTERSTOWN RD. BALTIMORE, MD 21215

CONTRACT NO. GS 21822

PHOTO LOCATION KEY PLAN

8/03/2022

SHEET **G-004**

BID DOCUMENTS

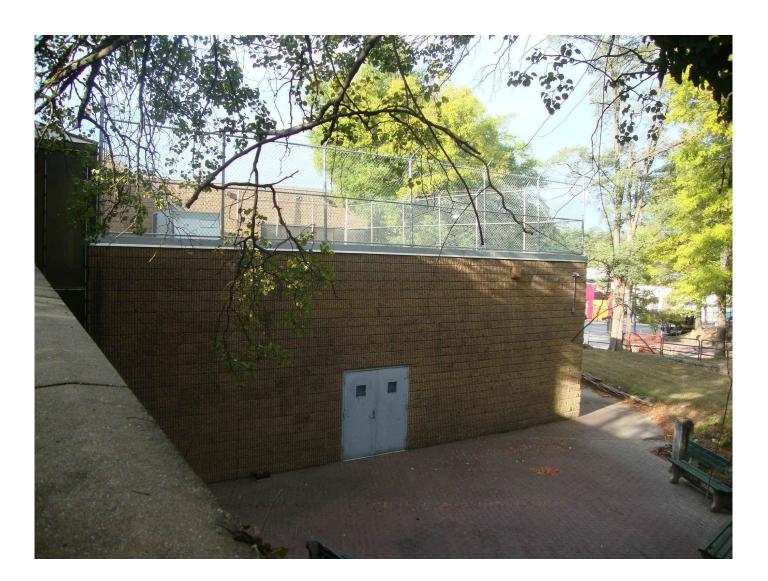


PHOTO # 1 - FACADE AT TERRACE ROOF

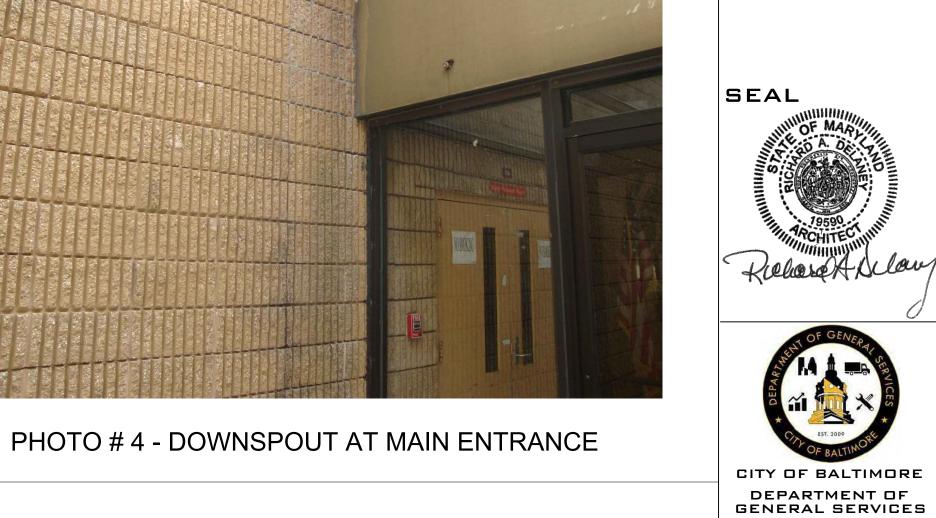


PHOTO # 2 - TERRACE ROOF



PHOTO #3 - FACADE AT TERRACE ROOF





CONSULTANTS

Suite 300 | Baltimore, Maryland 21228 p (410) 654-3790

www.primeeng.com

DESIGN AND CONSTRUCTION DIVISION

REVISIONS

... DATE DESCRIPTION



PHOTO # 5 - TRANSITION BETWEEN PARAPET WALL AND TRANSLUCENT WALL PANELS AT TERRACE ROOF



PHOTO # 6 - TRANSLUCENT WALL PANELS AT TERRACE ROOF



PHOTO # 7 - DUNNAGE FOR ROOF TOP UNIT AT TERRACE ROOF

PHOTO # 11 - NOT USED



PHOTO #8 - TERRACE ROOF BETWEEN ROOF TOP UNIT AND WALL



PHOTO # 9 - TERRACE ROOF, PARAPET SCUPPER



PHOTO # 10 - FENCE SUPPORT AT PARAPET WALL



PHOTO # 12 - ROOF DRAIN AT MAIN ROOF



G-005 6 OF 30

COX

SHEET NAME

PHOTO

SHEET

8/03/2022

SHEET

BID DOCUMENTS



PHOTO # 13 - STAIR TOWER DOOR

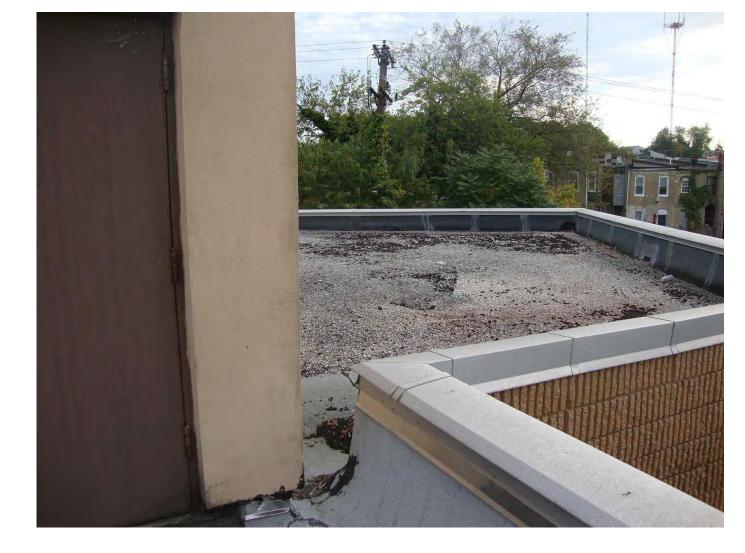


PHOTO # 14 - STAIR TOWER / PARAPET WALL



PHOTO # 15 - SKYLIGHT AT MAIN ROOF



PHOTO # 16 - MAIN ROOF





PHOTO # 17 - GAS LINE AT MAIN ROOF



PHOTO # 18 - PARAPET/SKYLIGHT TRANSITION



PHOTO # 19 - ELEVATOR ROOF

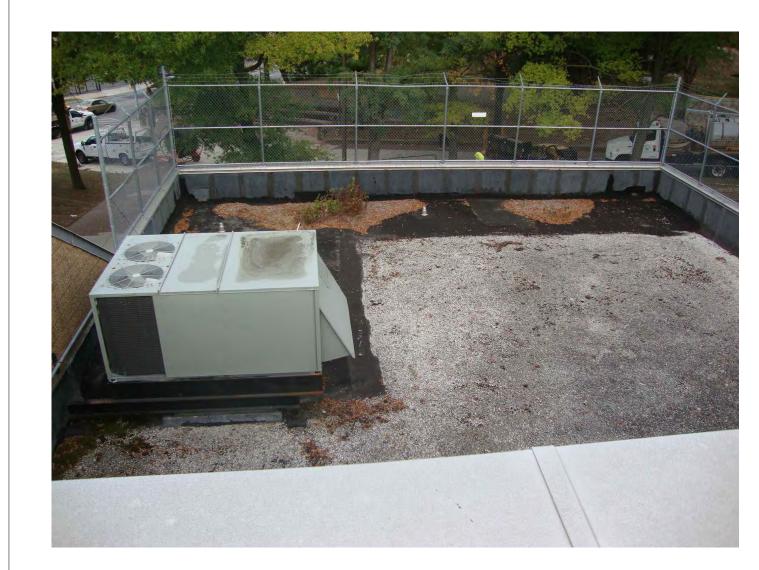


PHOTO # 20 - TERRACE ROOF



PHOTO # 21 - ROOF TOP UNIT ON DUNNAGE AND CONDUIT PENETRATION



PHOTO # 22 - MAIN ROOF PARAPET AT FENCE



PHOTO # 23 - ROOFTOP EQUIPMENT



PHOTO # 24 - STAIR TOWER ROOF

RI	EVISIONS
 DATE	DESCRIPTION
 1	

CITY OF BALTIMORE

DEPARTMENT OF GENERAL SERVICES

DESIGN AND CONSTRUCTION DIVISION

CONSULTANTS

SHEET NAME

PHOTO SHEET

8/03/2022

SHEET G-006

BID DOCUMENTS



PHOTO # 25 - ROOF DRAIN NEAR STAIR TOWER




PHOTO # 26 - STAIR TOWER



PHOTO # 27 - THROUGH WALL SCUPPER



PHOTO # 28 - EXHAUST FAN

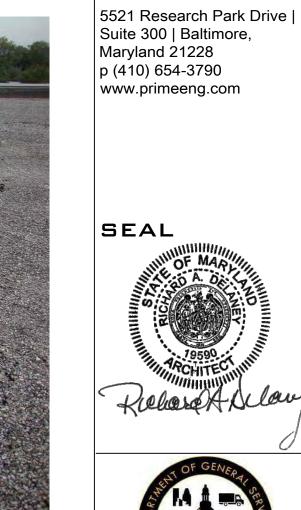

CONSULTANTS

CITY OF BALTIMORE DEPARTMENT OF GENERAL SERVICES DESIGN AND CONSTRUCTION DIVISION



PHOTO # 29 - SEALANT JOINT AT FLUTED BLOCK

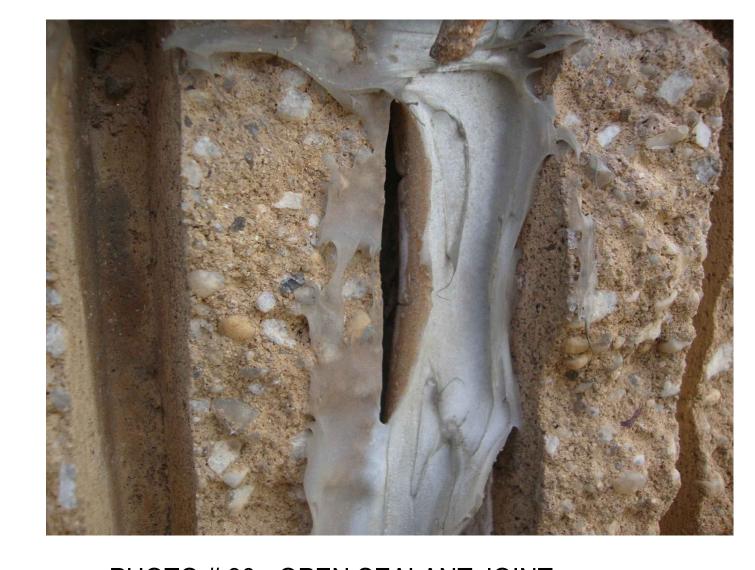


PHOTO # 30 - OPEN SEALANT JOINT

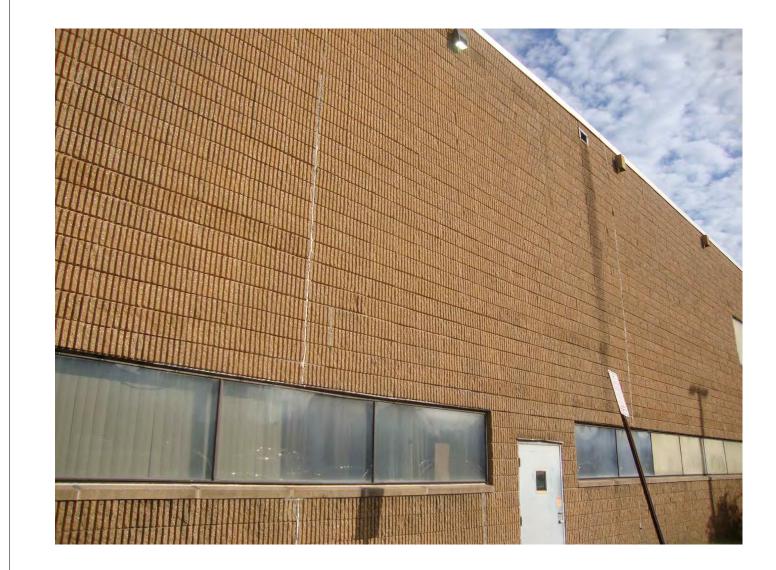


PHOTO # 31 - SPLIT FACE FLUTED BLOCK AT WALL



PHOTO # 32 - GAS LINE AT MAIN ROOF



PHOTO # 33 - ROOF DRAIN ON MAIN ROOF



PHOTO # 34 - ROOF TOP UNIT ON DUNNAGE SUPPORTS



PHOTO # 35 - ELEVATOR ROOF



PHOTO # 36 - STAIR TOWER ROOF

	REVISIONS					
DATE DESCRIPTION						

3HTS ER ROOF ' L REPAIR


SHEET NAME

PHOTO SHEET

8/03/2022

SHEET G-007

BID DOCUMENTS

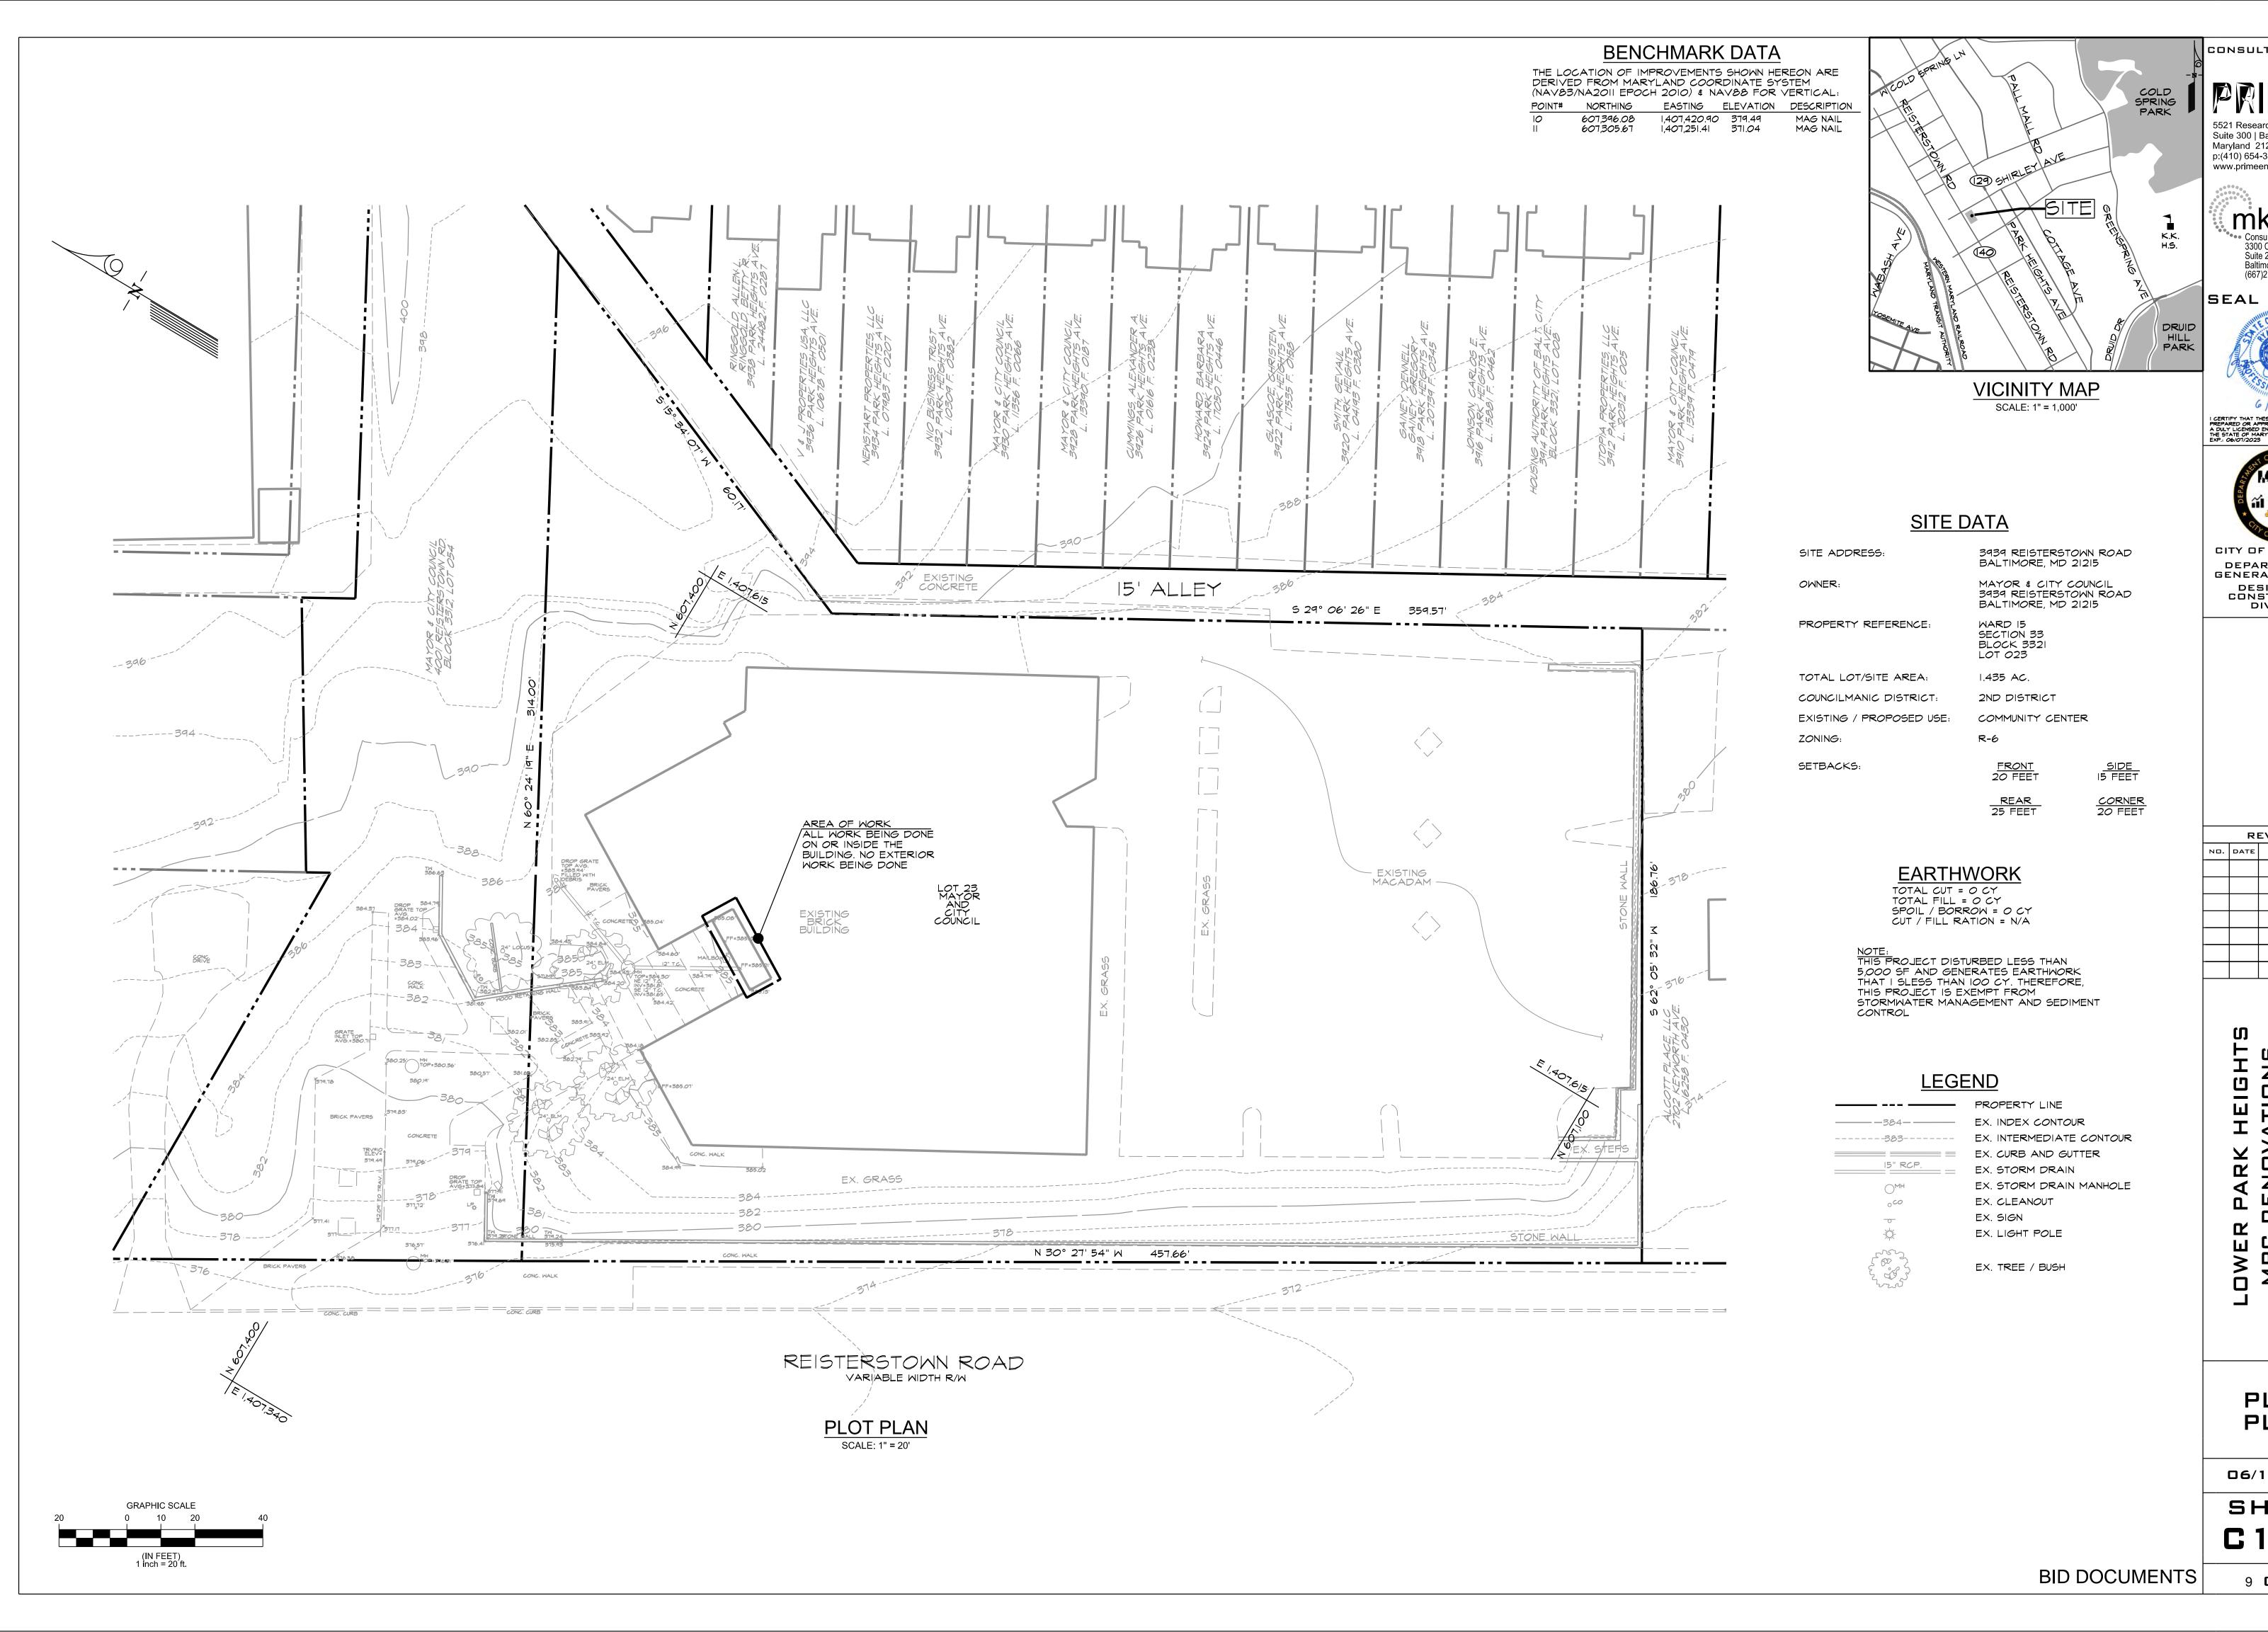

CONSULTANTS 5521 Research Park Drive Suite 300 | Baltimore, Maryland 21228 p:(410) 654-3790 www.primeeng.com

Consulting Engineers, LLC 3300 Clipper Mill Road Suite 201 Baltimore, MD 21211 (667)210-2479

SEAL

CITY OF BALTIMORE

DEPARTMENT OF GENERAL SERVICES

DESIGN AND CONSTRUCTION DIVISION

REVISIONS

HEIGHT

LOWER


DESCRIPTION


PLOT PLAN

06/10/2022

SHEET C1.00

9 **DF** 30

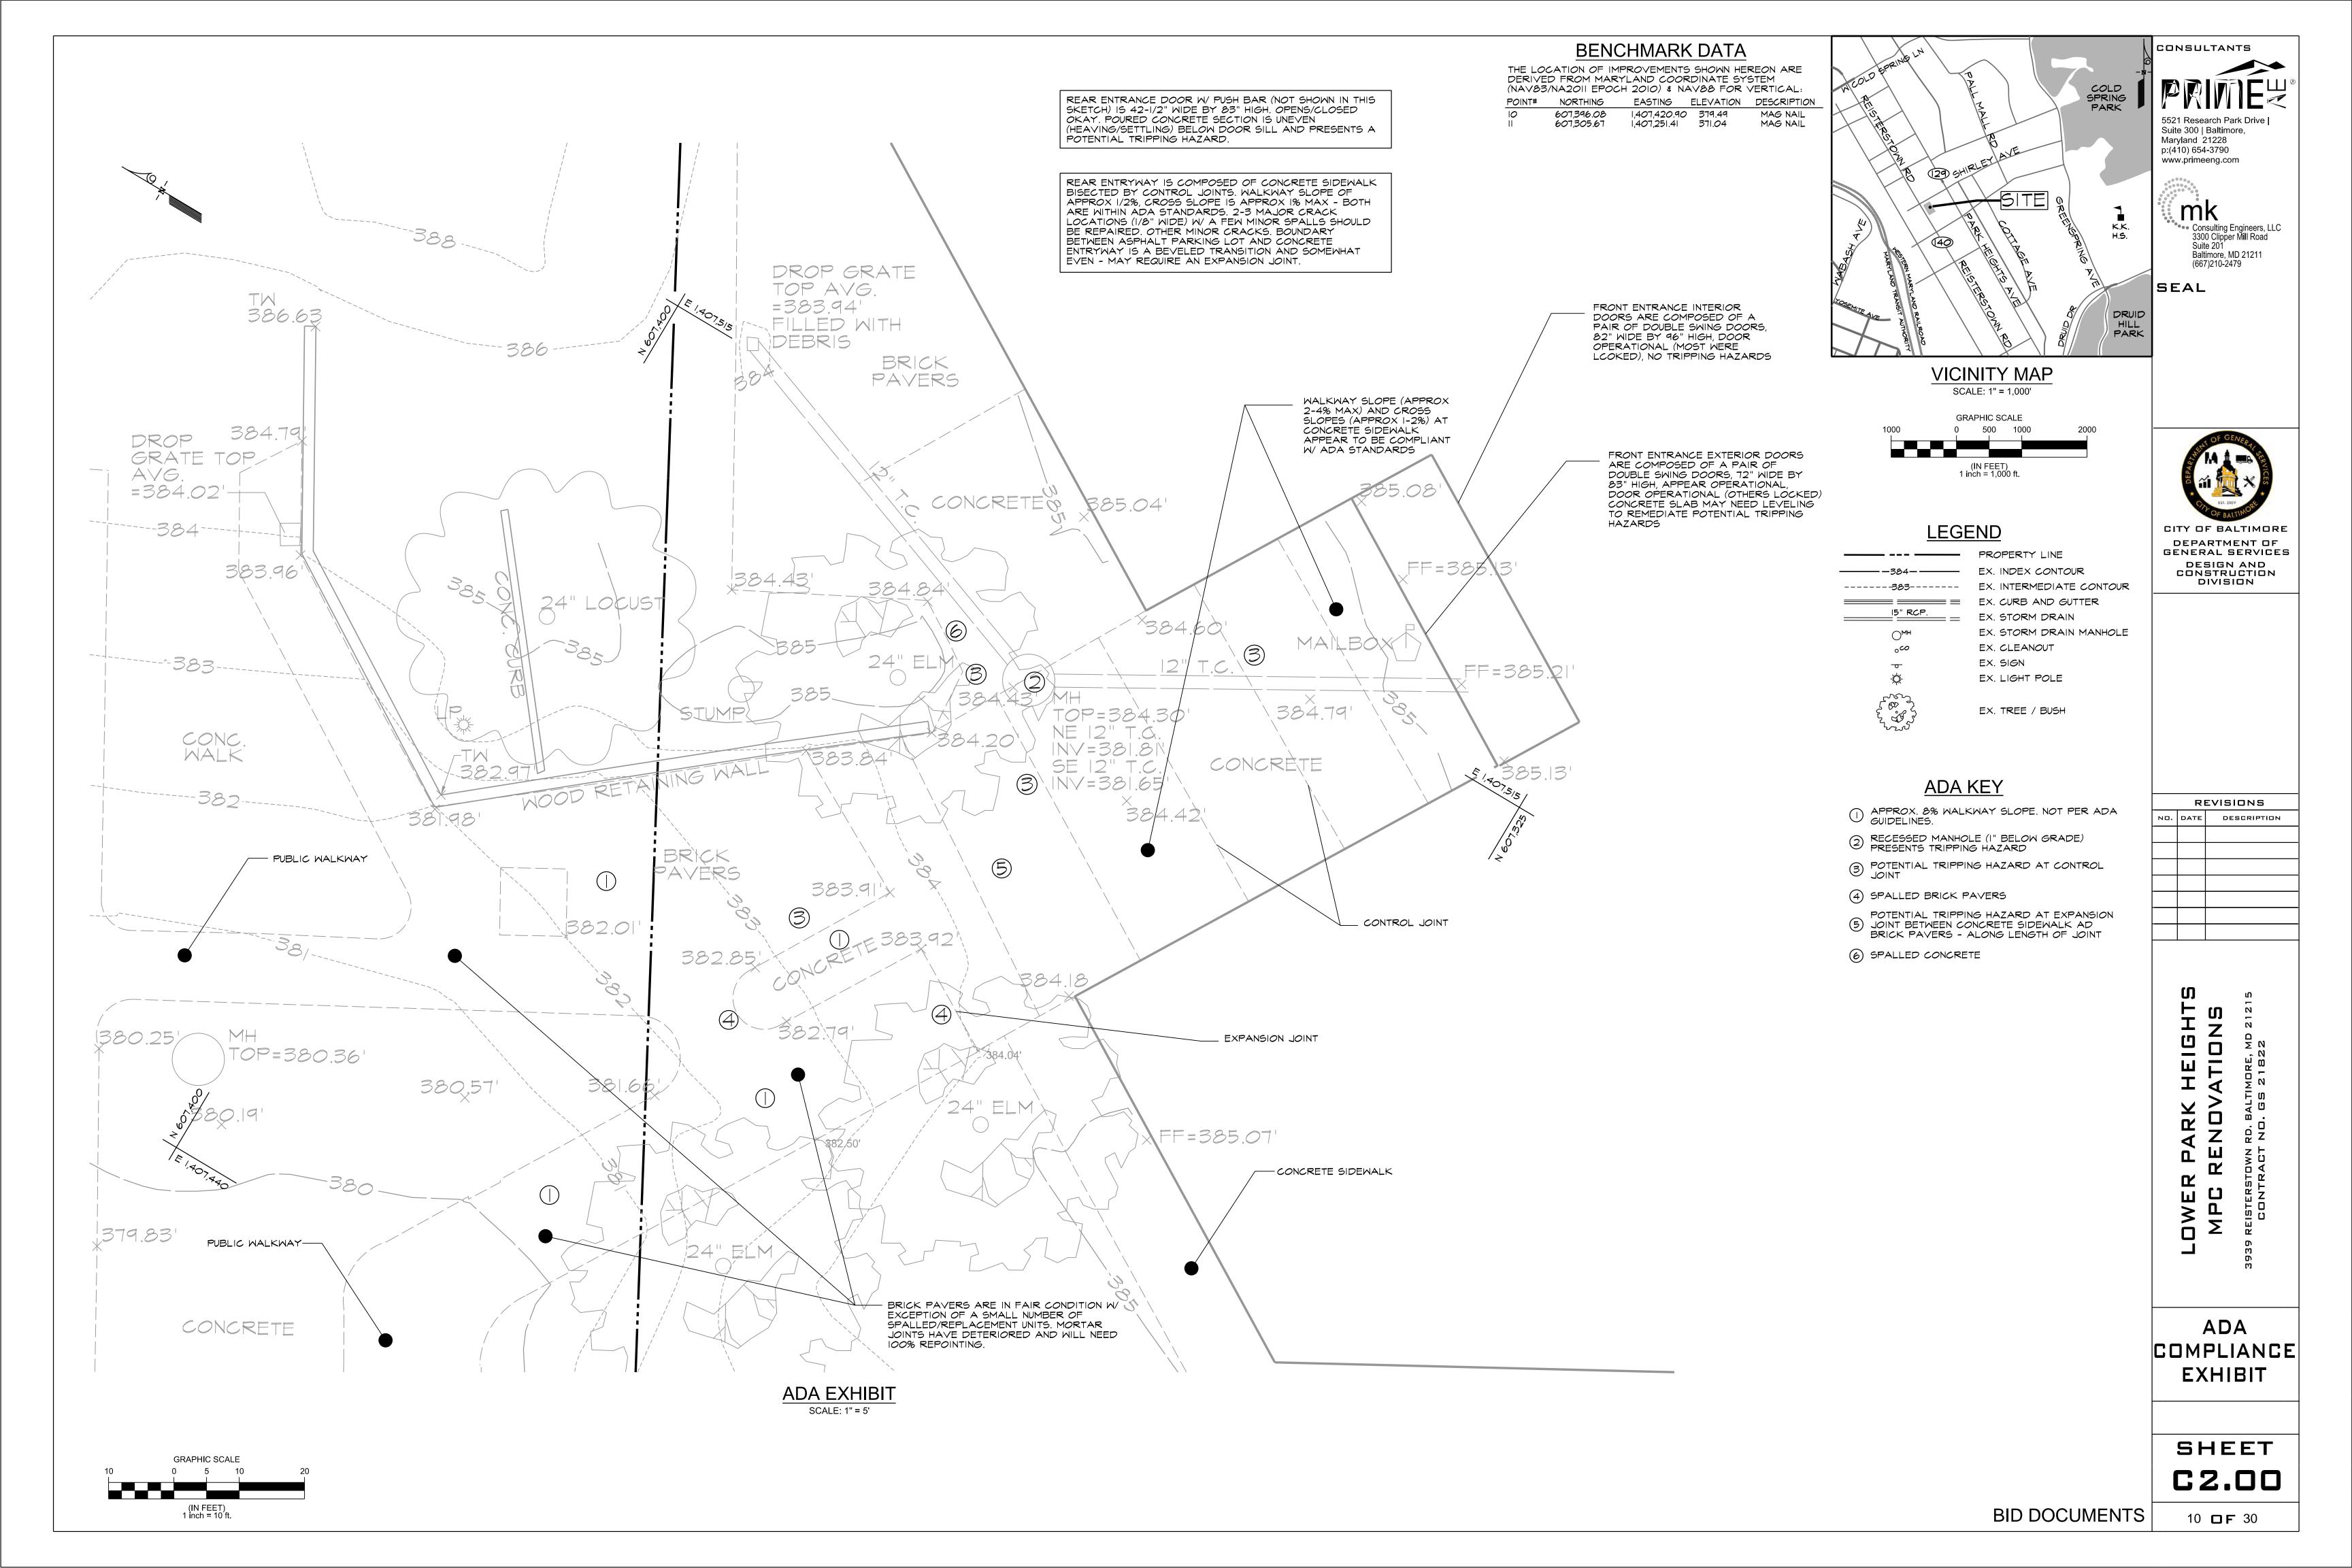

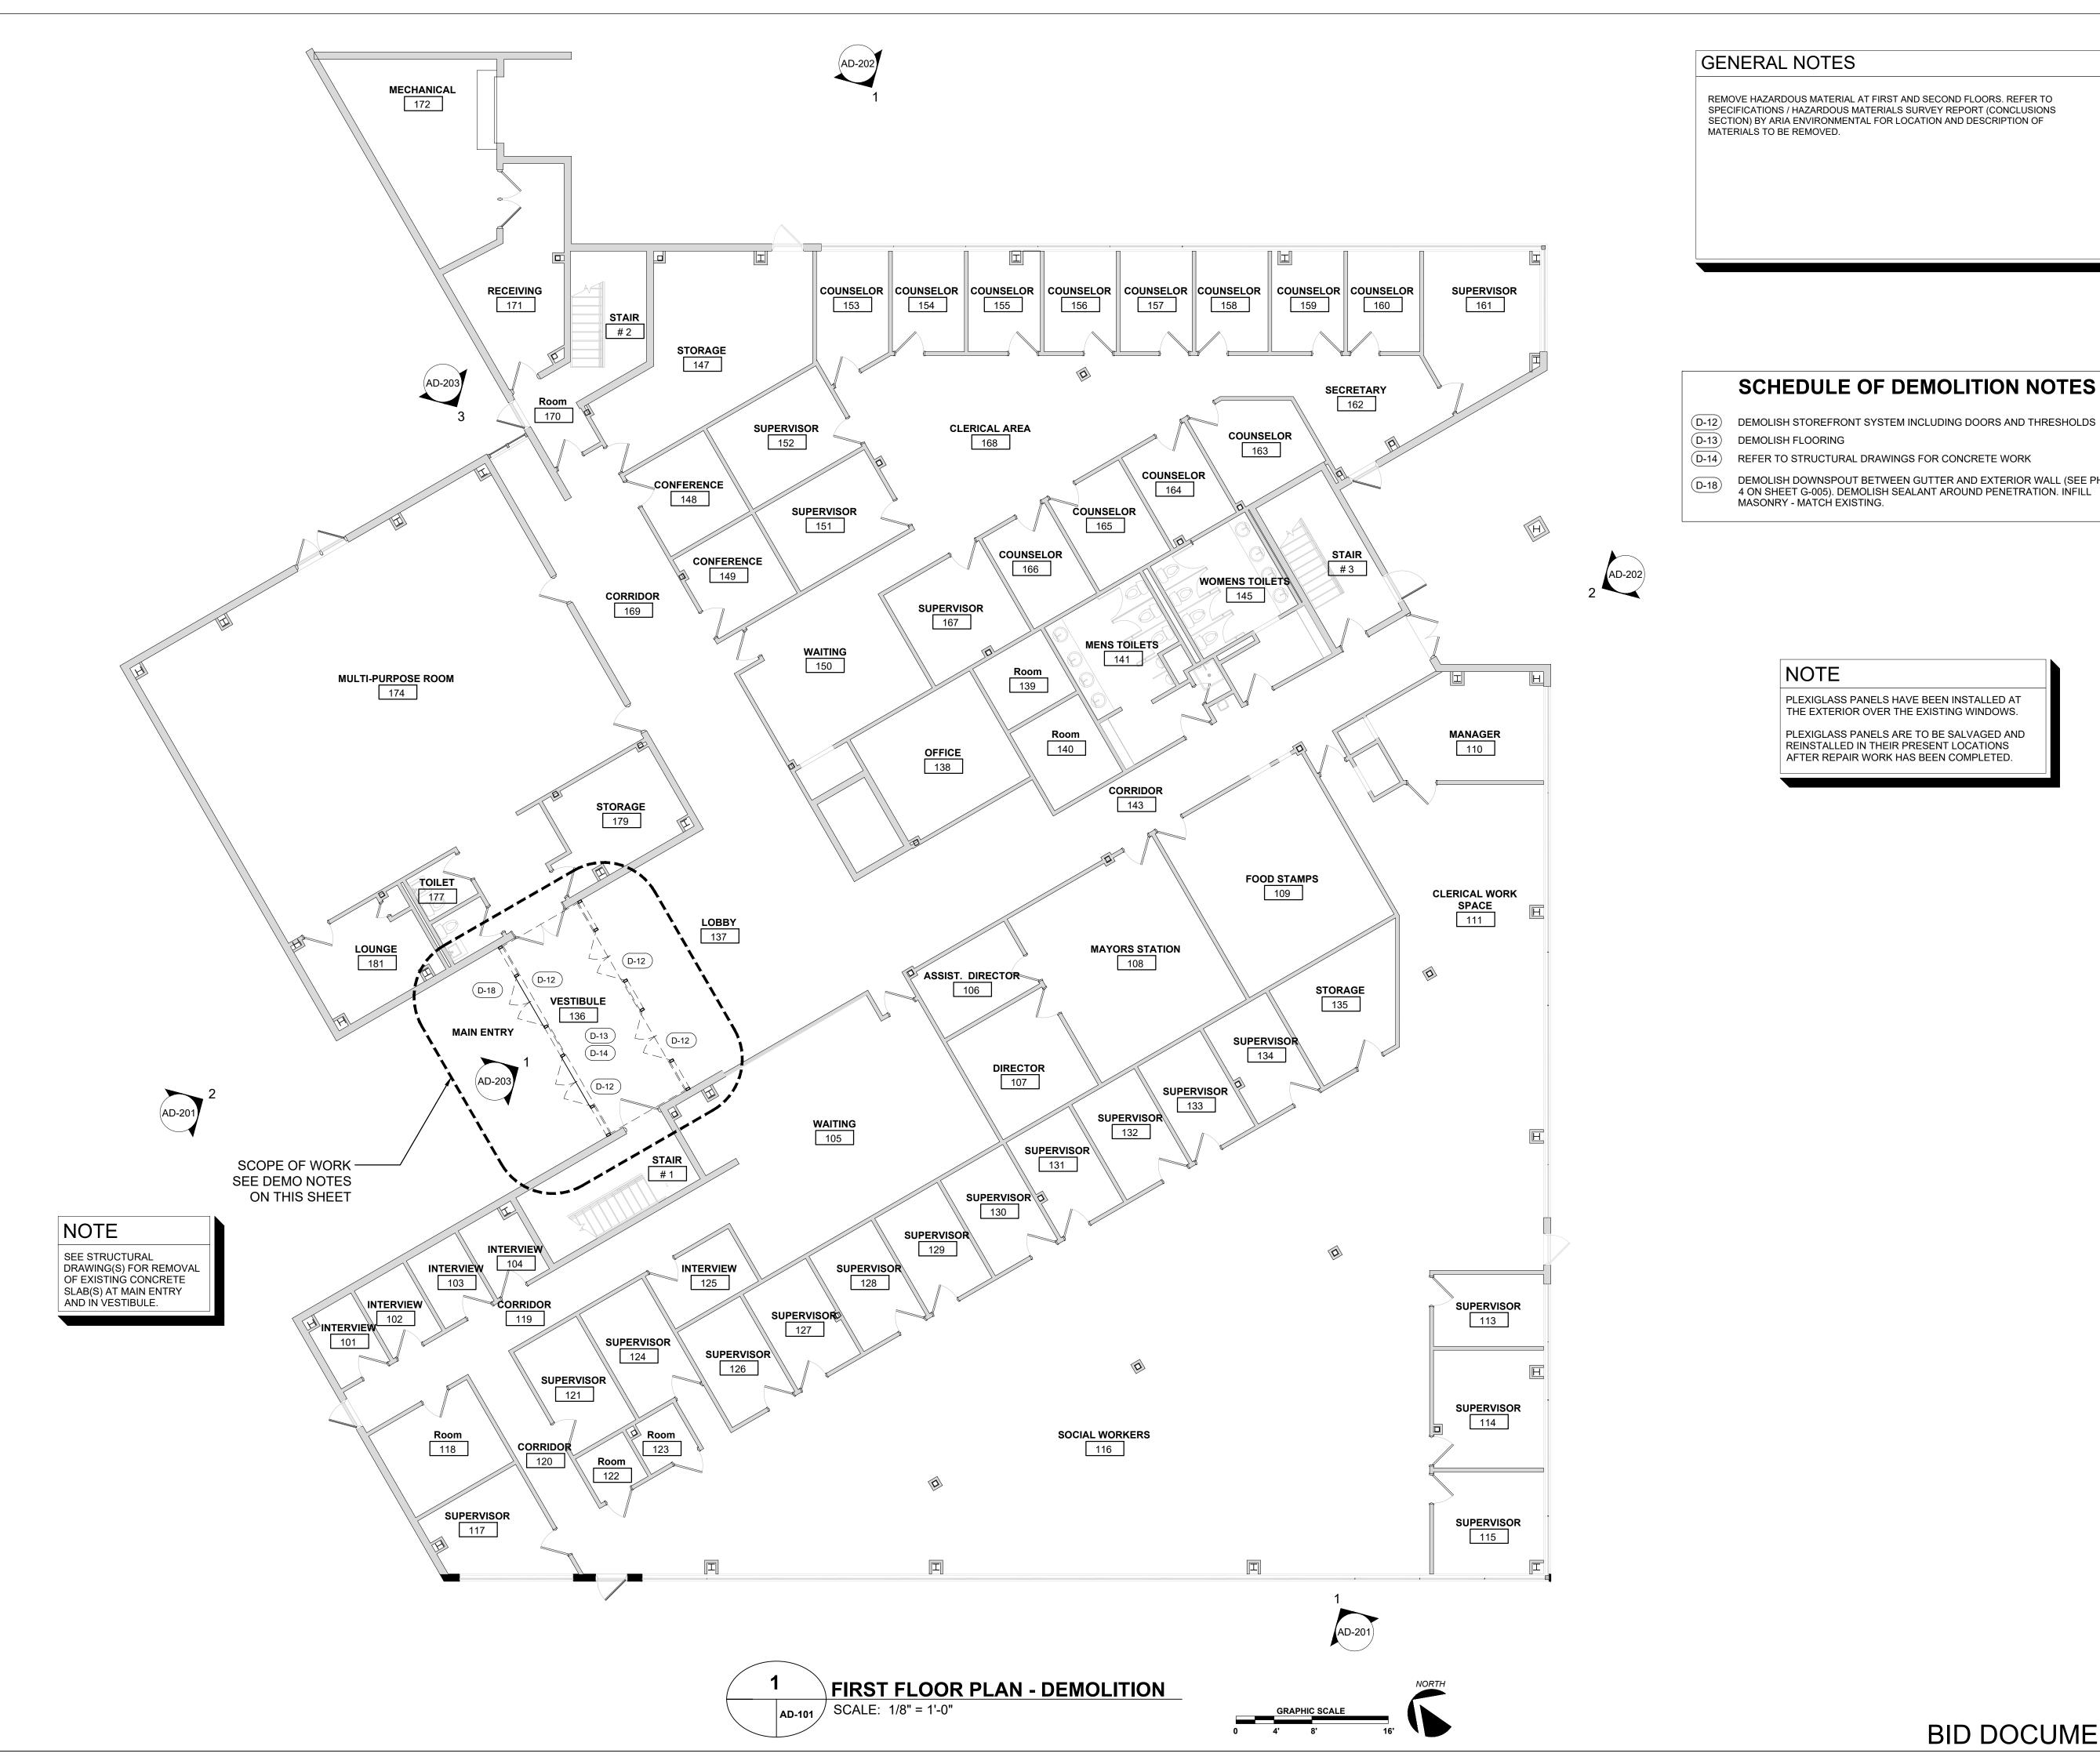

REMOVE HAZARDOUS MATERIAL AT FIRST AND SECOND FLOORS. REFER TO SPECIFICATIONS / HAZARDOUS MATERIALS SURVEY REPORT (CONCLUSIONS SECTION) BY ARIA ENVIRONMENTAL FOR LOCATION AND DESCRIPTION OF MATERIALS TO BE REMOVED.



Suite 300 | Baltimore, Maryland 21228 p (410) 654-3790 www.primeeng.com

SEAL



CITY OF BALTIMORE DEPARTMENT OF **GENERAL SERVICES** DESIGN AND CONSTRUCTION DIVISION

NOTE

PLEXIGLASS PANELS HAVE BEEN INSTALLED AT THE EXTERIOR OVER THE EXISTING WINDOWS. PLEXIGLASS PANELS ARE TO BE SALVAGED AND REINSTALLED IN THEIR PRESENT LOCATIONS

AFTER REPAIR WORK HAS BEEN COMPLETED.

SCHEDULE OF DEMOLITION NOTES

DEMOLISH DOWNSPOUT BETWEEN GUTTER AND EXTERIOR WALL (SEE PHOTO 4 ON SHEET G-005). DEMOLISH SEALANT AROUND PENETRATION. INFILL MASONRY - MATCH EXISTING.

REFER TO STRUCTURAL DRAWINGS FOR CONCRETE WORK

REVISIONS					
	DATE	DESCRIPTION			

'S ROOF '. REP/ COMMUN COMMUN REPLACE / ENTRY

SHEET NAME


FIRST FLOOR PLAN DEMOLITION

8/03/2022

SHEET **AD-101**

11 OF 30

BID DOCUMENTS

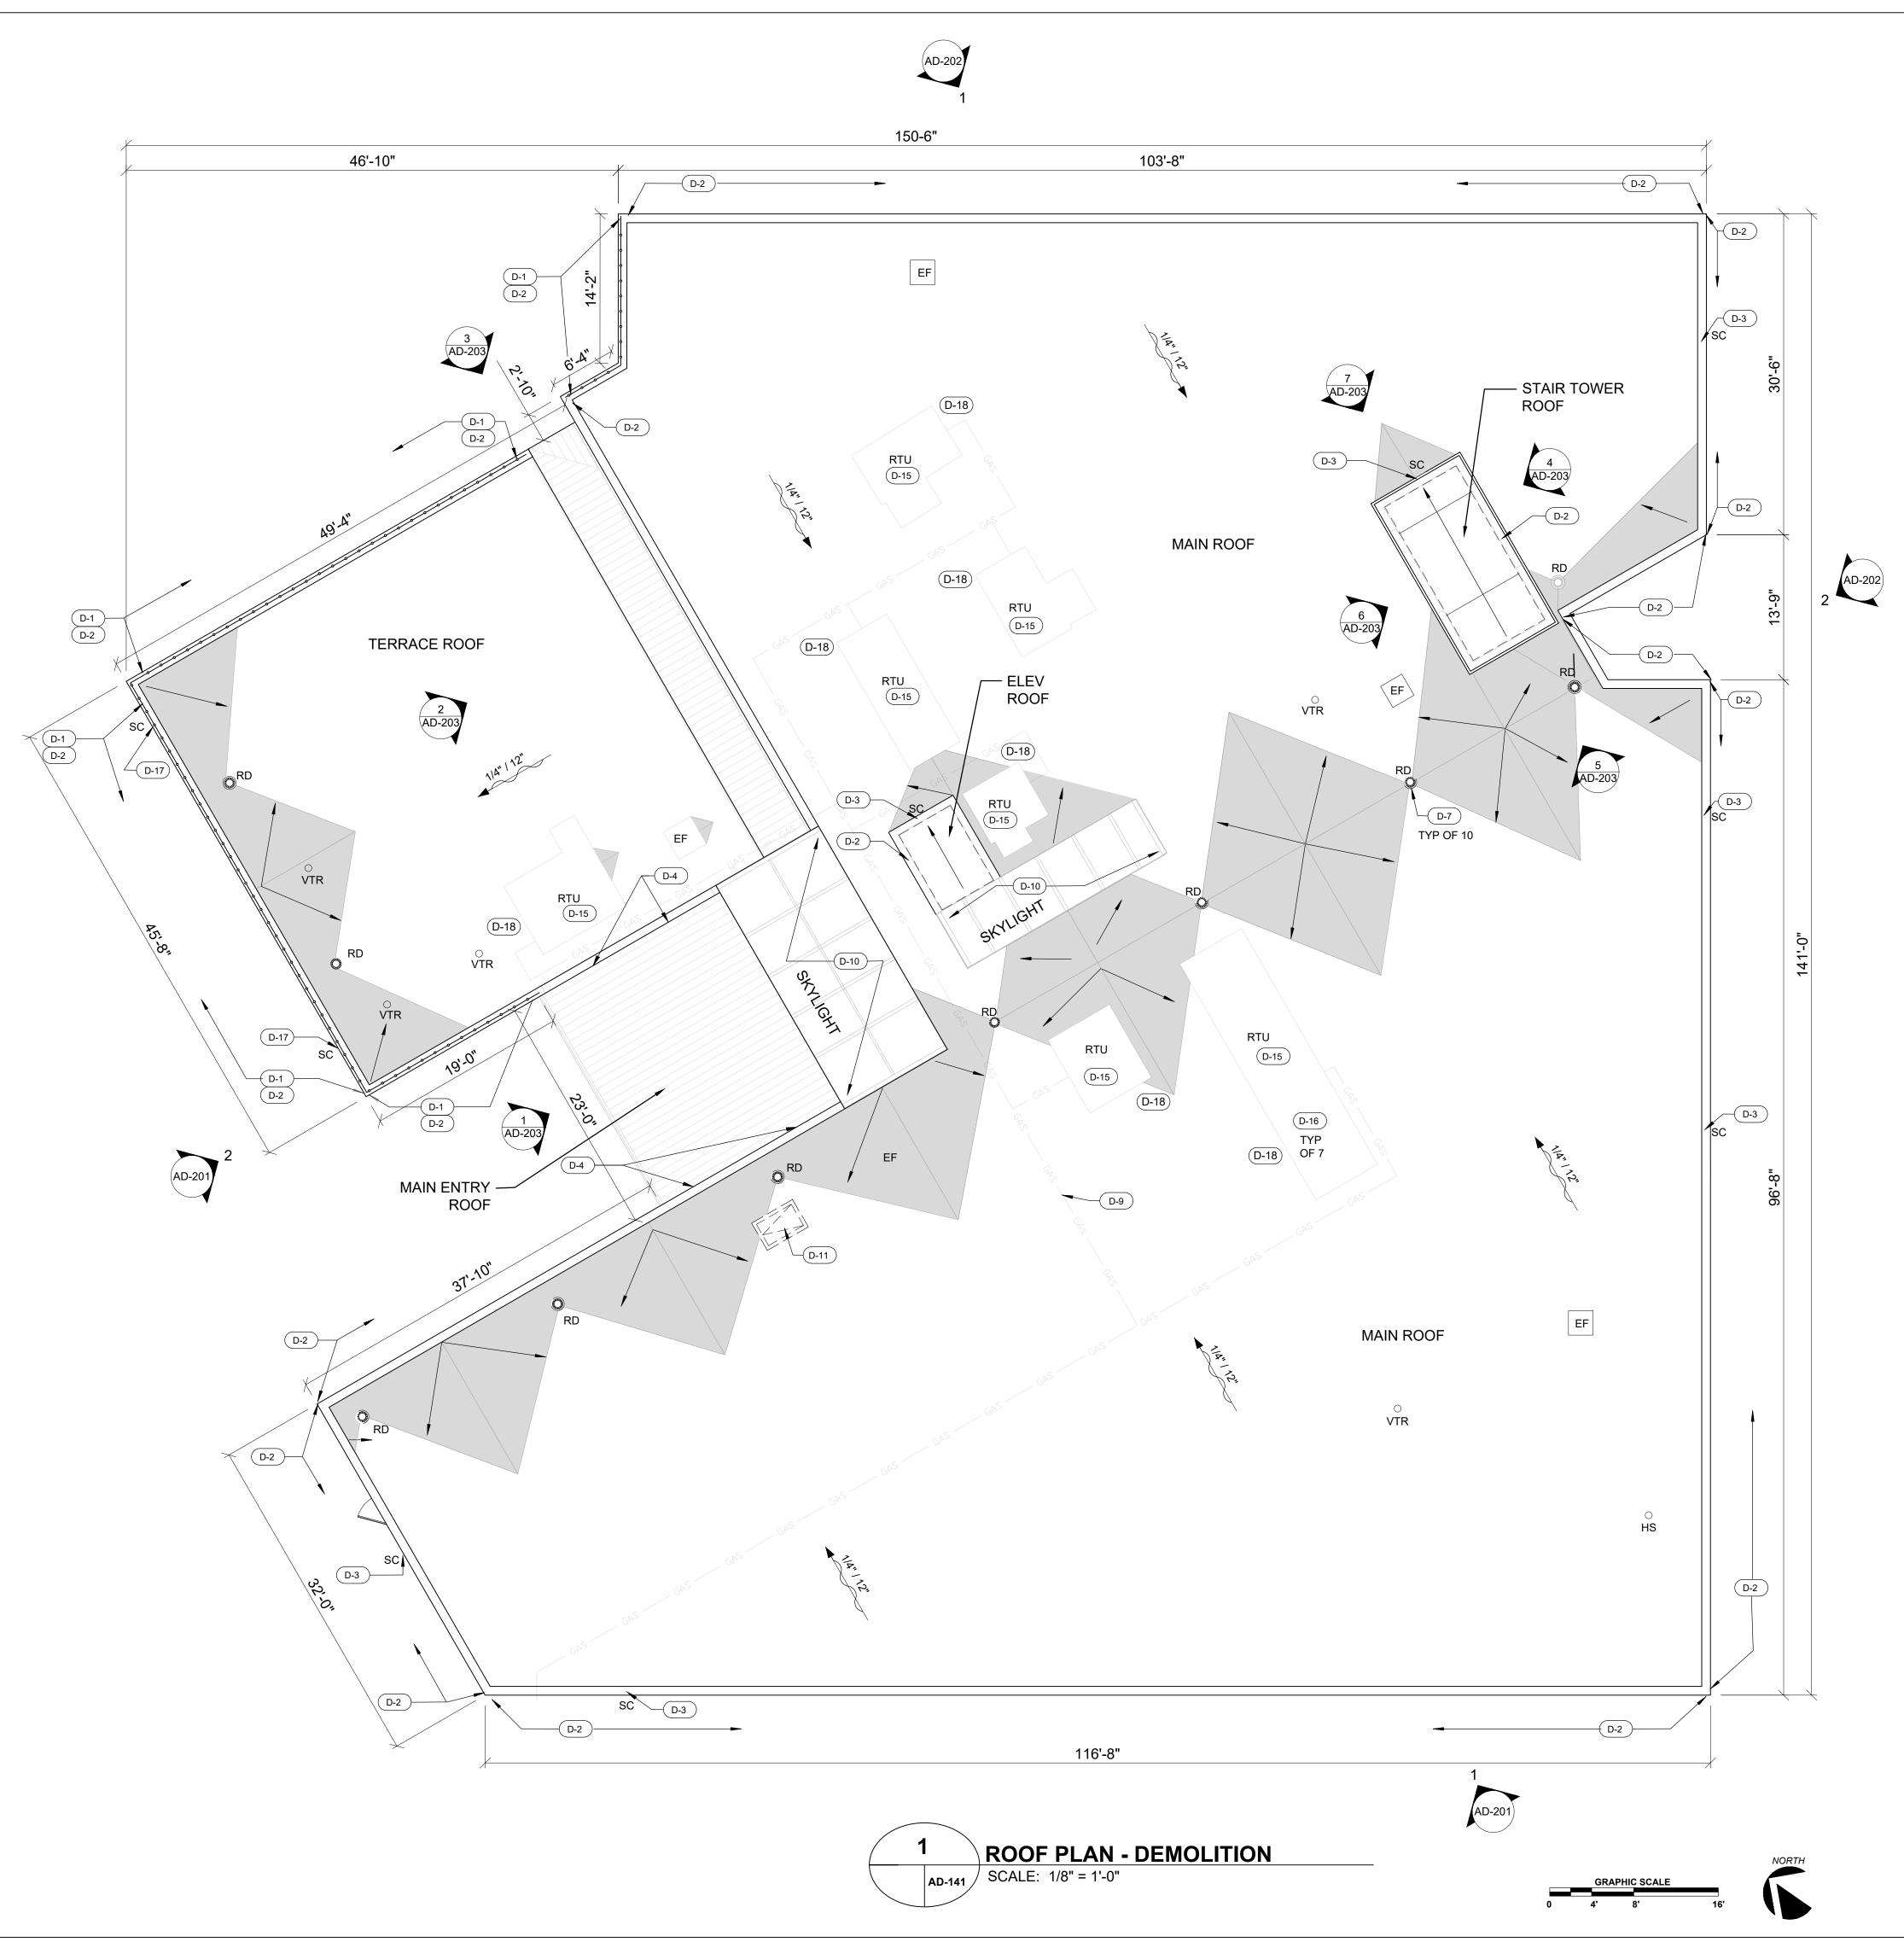

DEMOLISH EXISTING BUILT-UP ROOF ASSEMBLY DOWN TO STRUCTURAL STEEL DECK. APPROX. 7" THICK AT ALL CORES, THE ORIGINAL ASSEMBLY APPROX. 3" THICK WITH THE CURRENT ASSEMBLY APPROX. 4" THICK. ASSEMBLY COMPOSITION:

1 1/2" METAL ROOF DECKING

• 2" PERLITE INSULATION MECHANICALLY ATTACHED TO THE ROOF

- 2 PLIES OF ORIGINAL BUILT-UP ROOF (BUR) ASPHALT MEMBRANE
- **GRAVEL SURFACE** • 2 PLIES OF BUILT-UP ROOF (BUR) ASPHALT MEMBRANE
- 2" POLYISOCYANURATE INSULATION PERLITE INSULATION HOT MOPPED TO INSULATION
- 3 PLIES OF BUILT-UP ROOF (BUR) ASPHALT MEMBRANE

GRAVEL SURFACE

FOR LOCATION AND DESCRIPTION OF MATERIALS TO BE REMOVED.

REMOVE HAZARDOUS MATERIAL. REFER TO SPECIFICATIONS / HAZARDOUS

MATERIALS SURVEY REPORT (CONCLUSIONS SECTION) BY ARIA ENVIRONMENTAL

EXISTING STANDING SEAM ROOF TO REMAIN (OUT OF SCOPE)

EXISTING SADDLES AND CRICKETS TO BE DEMOLISHED

■ INDICATES ROOF SLOPE ON THE STRUCTURAL DECK SLOPE

ABBREVIATIONS

- EXHAUST FAN HOT STACK
- **ROOF DRAIN**
- **ROOF TOP UNIT**
- RTU SC SCUPPER

VENT THRU ROOF

SEAL

CONSULTANTS

5521 Research Park Drive |

Suite 300 | Baltimore,

Maryland 21228

p (410) 654-3790

www.primeeng.com





GENERAL SERVICES DESIGN AND CONSTRUCTION DIVISION

SCHEDULE OF DEMOLITION NOTES

- D-1 REMOVE CHAIN-LINK FENCING SALVAGE FOR REINSTALLATION AFTER NEW ROOF IS INSTALLED.
- (D-2) DEMOLISH EXISTING METAL COPING AND WOOD BLOCKING BENEATH.
- D-3 DEMOLISH EXISTING THROUGH-WALL SCUPPER FLASHINGS.
- D-4 DEMOLISH STEP FLASHING AND SEALANT.
- (D-7) DEMOLISH EXISTING ROOF DRAIN AND COMPONENTS DOWN TO THE DECK (TYP).
- D-9 TEMPORARILY REMOVE GAS LINE FOR NEW ROOF SYSTEM INSTALLATION (TYP). DISPOSE OF WOOD BLOCKING SUPPORTS.
- (D-10) DEMOLISH EXISTING SEALANT AT SKYLIGHT.
- D-11 DEMOLISH EXISTING ROOF HATCH AND LADDER PENETRATION TO BE PATCHED WITH STEEL DECKING.
- D-15

 ROOF TOP UNIT TO REMAIN. DEMOLISH ALL EXISTING WATERPROOFING AND ROOFING COMPONENTS FROM STEEL SUPPORTS DOWN TO THE DECK. EXISTING STEEL SUPPORTS TO REMAIN. CLEAN AND PREP FOR PAINT.
- COORDINATE TEMPORARY SHUTDOWN OF MECHANICAL EQUIPMENT WITH THE
- D-17 DEMOLISH EXISTING THROUGH-WALL SCUPPER FLASHINGS. REMOVE MASONRY AS NECESSARY TO PROVIDE 8" HT X 16" W OPENING.
- D-18 DEMOLISH EXISTING SERVICE LINE PENETRATION AND ROOF FLASHINGS. DISCONNECT SERVICE LINES AS REQUIRED TO ALLOW SPECIFIED WORK. PATCH PENETRATIONS W/ STEEL DECKING.

OF		

REVISIONS

... DATE DESCRIPTION

 Ω OWER FOR MONTHER FOR THE PLACE

SHEET NAME

ROOF PLAN DEMOLITION

8/03/2022

SHEET **AD-141**

BID DOCUMENTS

CLEAN ALL EXTERIOR CONCRETE MASONRY TO REMOVE DIRT, STAINING, AND EFFLORESCENCE.

 \square \square INDICATES ITEM TO BE DEMOLISHED

ABBREVIATION LEGEND:

CJ REMOVE EXISTING SEALANT AND BACKER RODS FROM ALL MASONRY CONTROL JOINTS. CLEAN AND PREP JOINT SUBSTRATES FOR NEW BACKER ROD AND SEALANT.


Suite 300 | Baltimore, Maryland 21228 p (410) 654-3790 www.primeeng.com

CONSULTANTS

SCHEDULE OF DEMOLITION NOTES

(D-6) DEMOLISH GLAZING BEADS, PERIMETER SEALANTS AND BACKER RODS.

D-18 DEMOLISH SEALANT AT CONTROL JOINT.

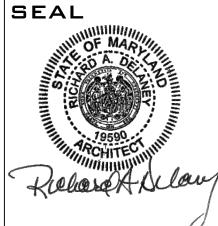



CITY OF BALTIMORE DEPARTMENT OF **GENERAL SERVICES** DESIGN AND CONSTRUCTION DIVISION

REVISIONS DATE DESCRIPTION

COMMUNITY CEN REPLACEMENT / / ENTRY


SHEET NAME

DEMOLITION **ELEVATIONS**

8/03/2022

SHEET **AD-201**

BID DOCUMENTS

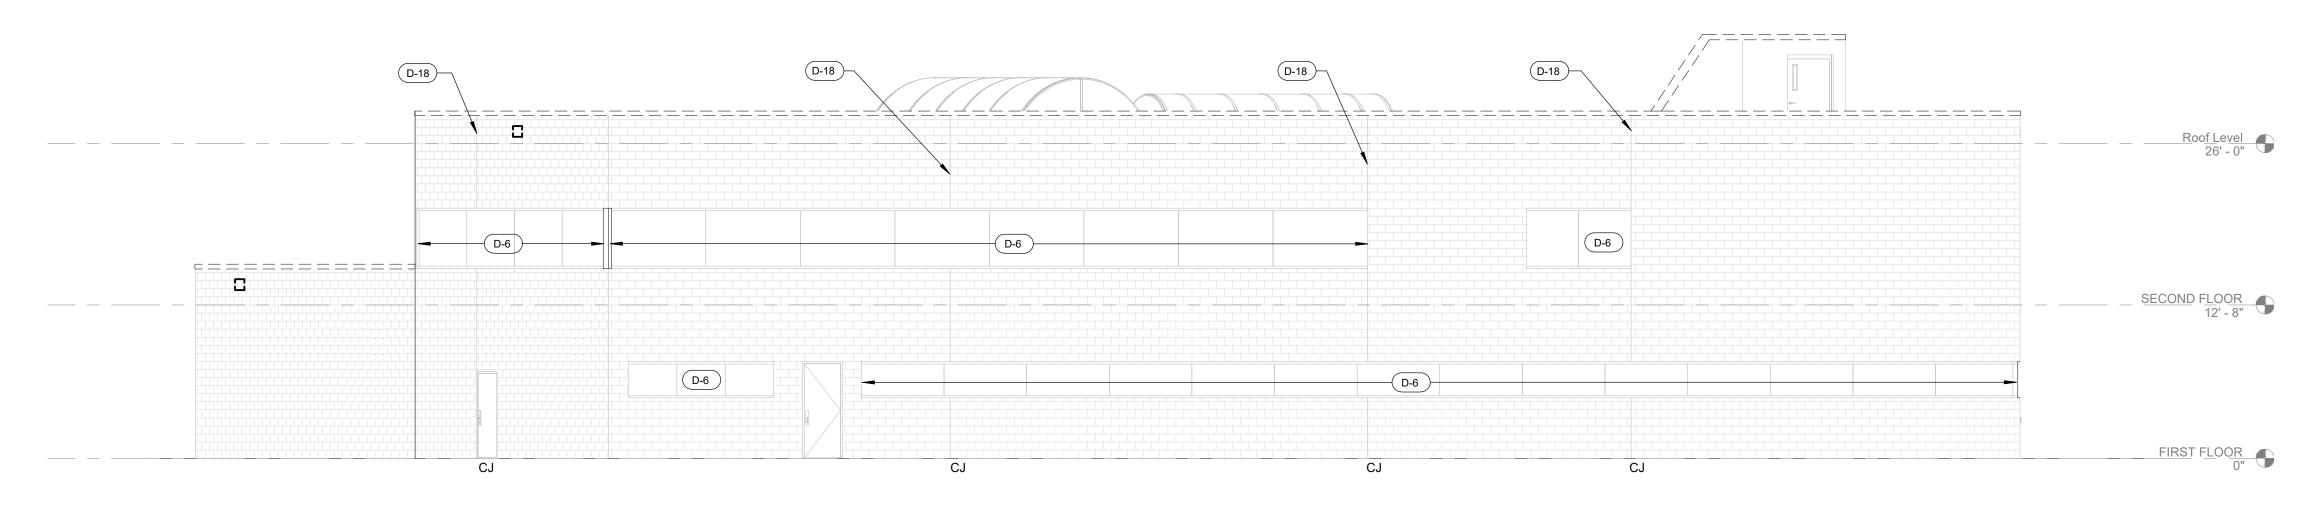



WEST ELEVATION DEMOLITION SCALE: 1/8" = 1'-0"

PLEXIGLASS PANELS ARE TO BE REUSED AND REINSTALLED IN THEIR PRESENT LOCATIONS AFTER REPAIR WORK HAS BEEN COMPLETED.

NOTE

PLEXIGLASS PANELS HAVE BEEN INSTALLED AT THE EXTERIOR OVER THE EXISTING WINDOWS.

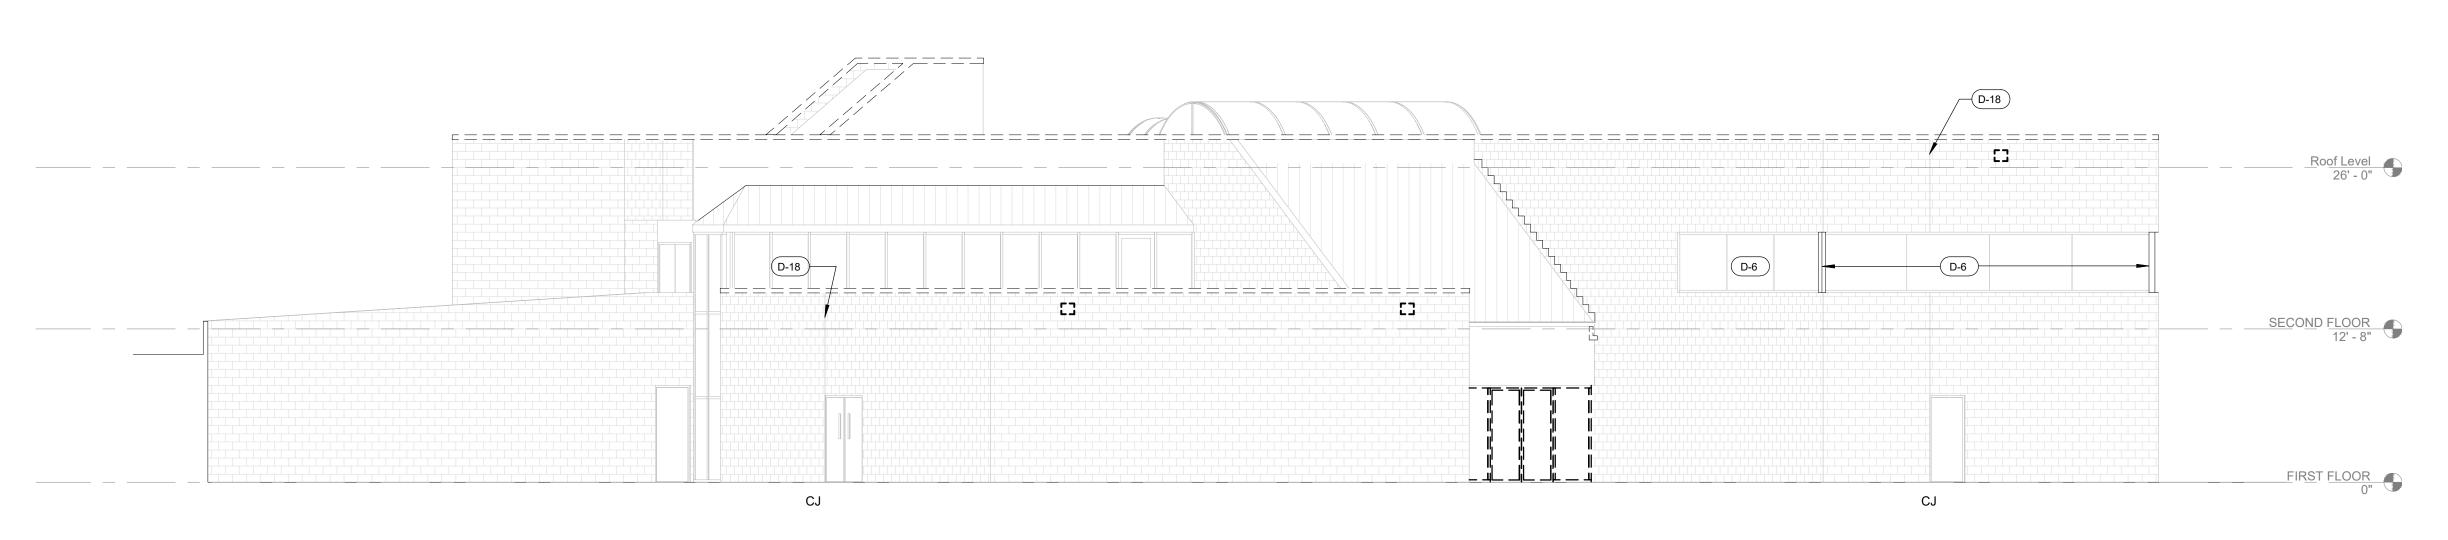

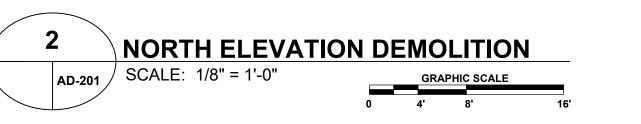

CLEAN ALL EXTERIOR CONCRETE MASONRY TO REMOVE DIRT, STAINING, AND EFFLORESCENCE.

☐ ☐ ☐ INDICATES ITEM TO BE DEMOLISHED

ABBREVIATION LEGEND:

CJ REMOVE EXISTING SEALANT AND BACKER RODS FROM ALL MASONRY CONTROL JOINTS. CLEAN AND PREP JOINT SUBSTRATES FOR NEW BACKER ROD AND SEALANT.

Suite 300 | Baltimore, Maryland 21228 p (410) 654-3790 www.primeeng.com


CONSULTANTS

SCHEDULE OF DEMOLITION NOTES

(D-5) DEMOLISH LINTEL. PROVIDE TEMPORARY SHORING OF MASONRY ABOVE.

(D-6) DEMOLISH GLAZING BEADS, PERIMETER SEALANTS AND BACKER RODS.

(D-18) DEMOLISH SEALANT AT CONTROL JOINT.

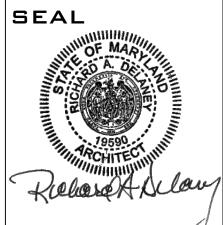





DEPARTMENT OF **GENERAL SERVICES** DESIGN AND CONSTRUCTION DIVISION

REVISIONS

... DATE DESCRIPTION

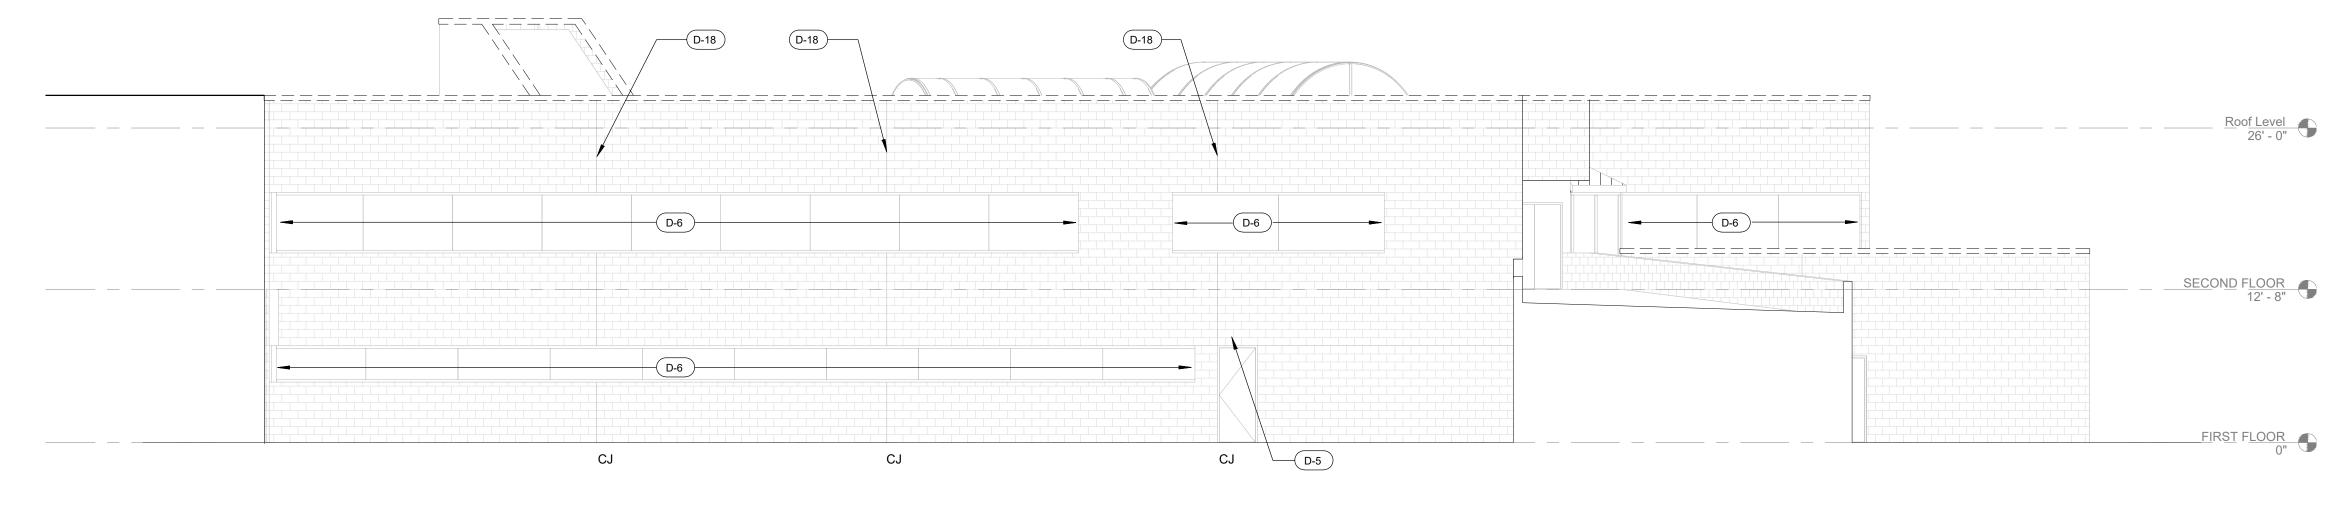


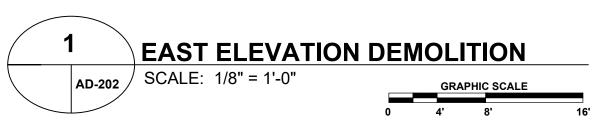

NOTE

PLEXIGLASS PANELS HAVE BEEN INSTALLED AT THE EXTERIOR OVER THE EXISTING WINDOWS.

PLEXIGLASS PANELS ARE TO BE REUSED AND REINSTALLED IN THEIR PRESENT LOCATIONS AFTER REPAIR WORK HAS BEEN COMPLETED.

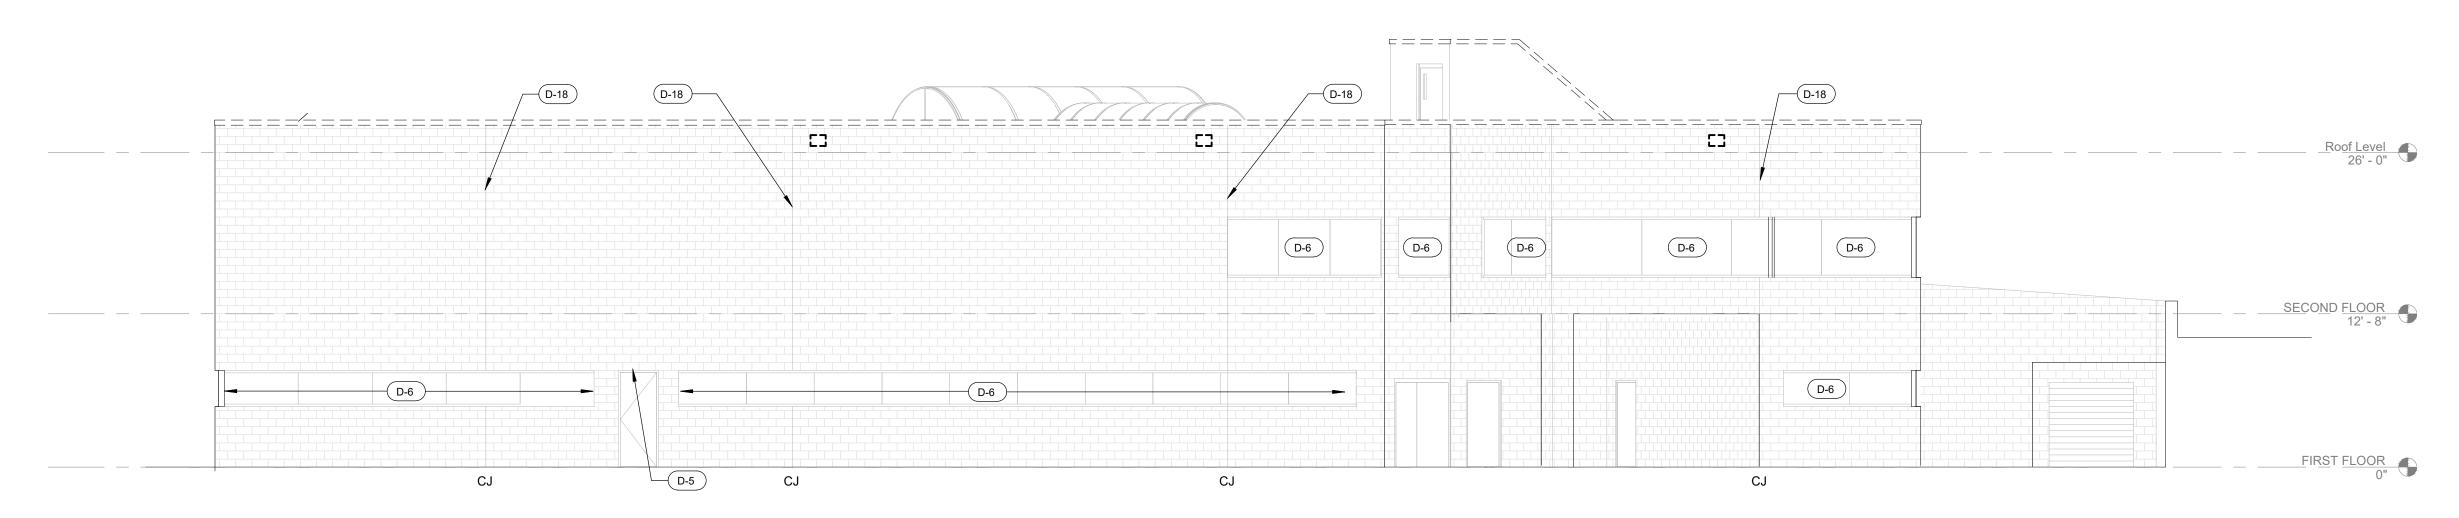




COMMUNITY CENTER ROOF
REPLACEMENT / WALL REPAIR
LENTRY
S939 REISTERSTOWN RD. BALTIMORE, MD 21215
CONTRACT NO. GS 21822


DEMOLITION **ELEVATIONS**


SHEET NAME


8/03/2022

SHEET **AD-202**

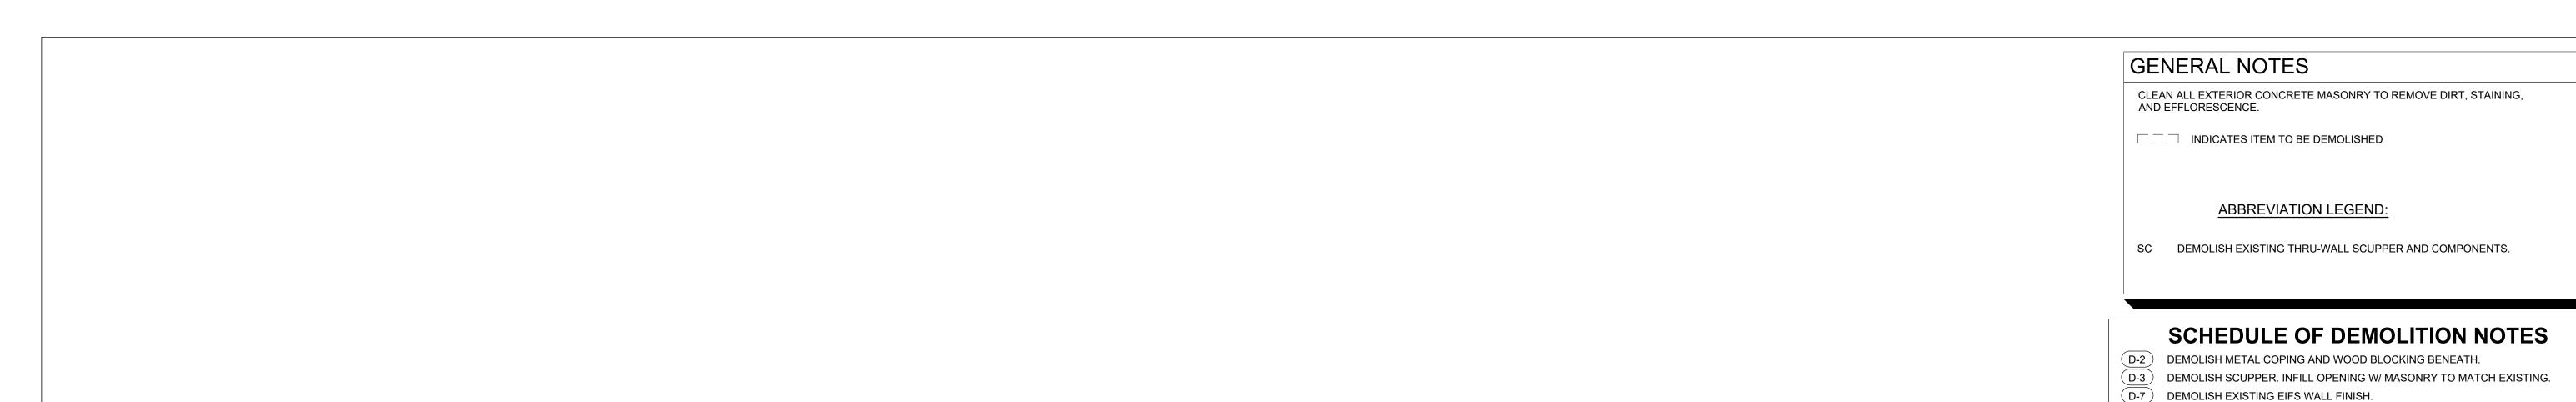

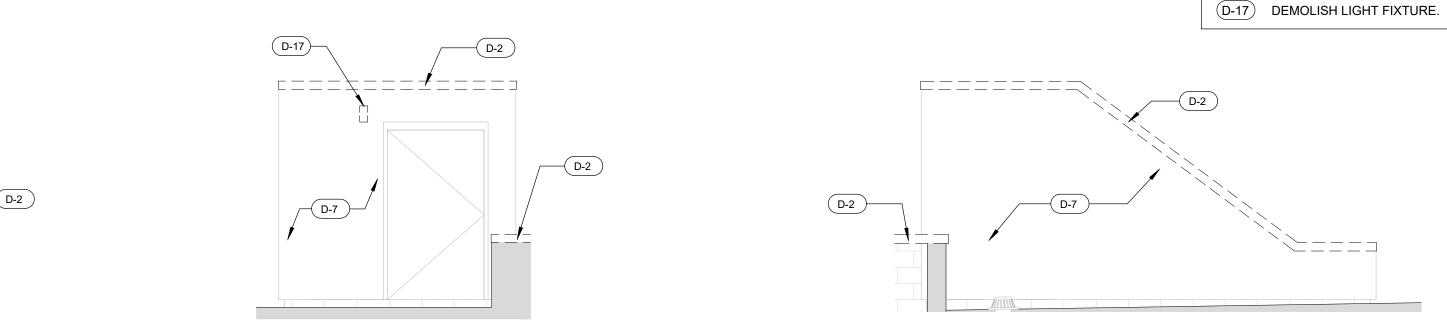

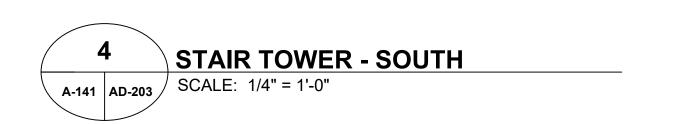

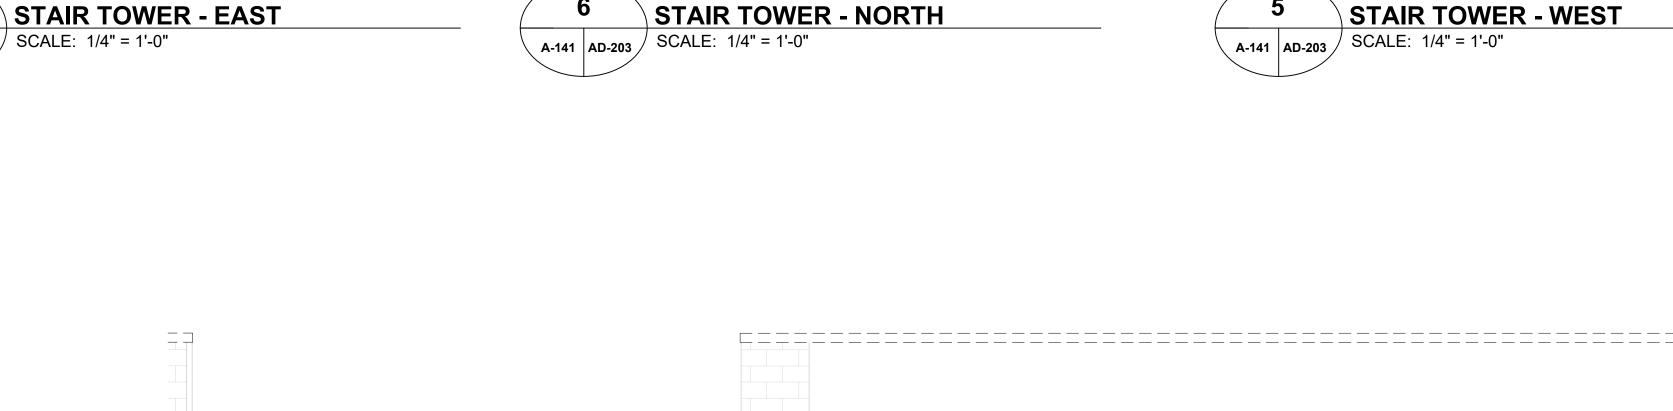


D-2


D-2

A-141 AD-203 /

PARTIAL EAST ELEVATION

A-141 AD-203 SCALE: 1/4" = 1'-0"

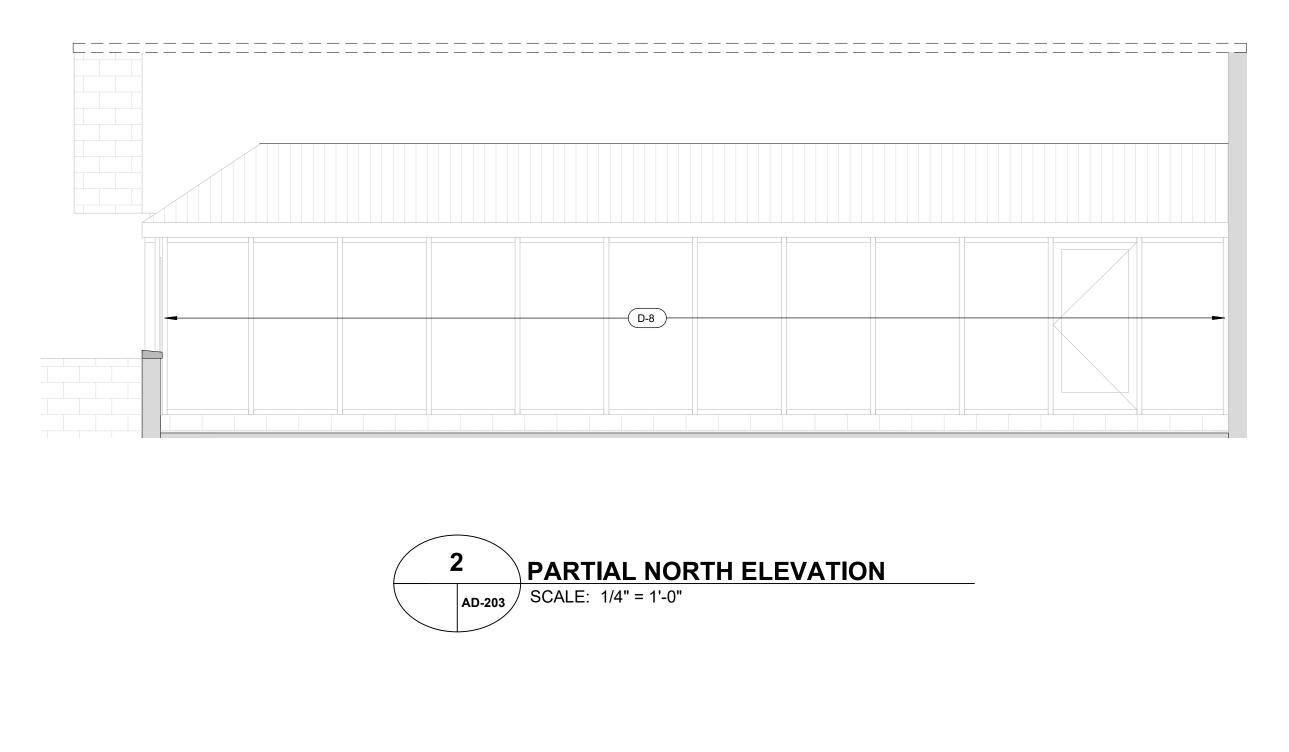

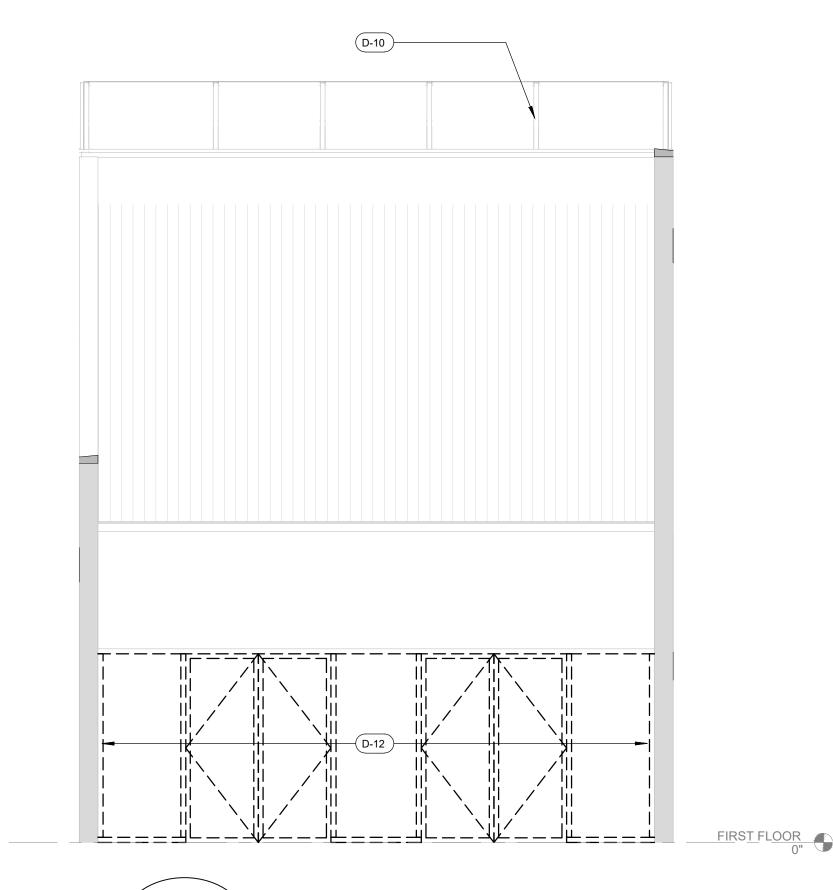

MAIN ENTRY ELEVATION AD-101 AD-203 SCALE: 1/4" = 1'-0"

DEMOLISH BACKER RODS AND SEALANTS AT TRANSLUCENT WALL PANELS.

(D-12) DEMOLISH STOREFRONT SYSTEM INCLUDING DOORS AND THRESHOLDS. (D-16) DEMOLISH EXISTING ROOFING AND FLASHINGS AT ACCESS STAIRWAY ROOF.


(D-10) DEMOLISH SEALANT AT SKYLIGHTS.

CONSULTANTS

Suite 300 | Baltimore, Maryland 21228 p (410) 654-3790 www.primeeng.com

SEAL



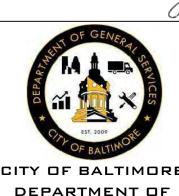

CITY OF BALTIMORE DEPARTMENT OF GENERAL SERVICES DESIGN AND CONSTRUCTION DIVISION

REVISIONS DESCRIPTION

COMMUNITY CENTER ROOF

REPLACEMENT / WALL REPAI

S939 REISTERSTOWN RD. BALTIMORE, MD 21215


CONTRACT NO. FE T.

SHEET NAME

DEMOLITION **ELEVATIONS**

8/03/2022

SHEET **AD-203**

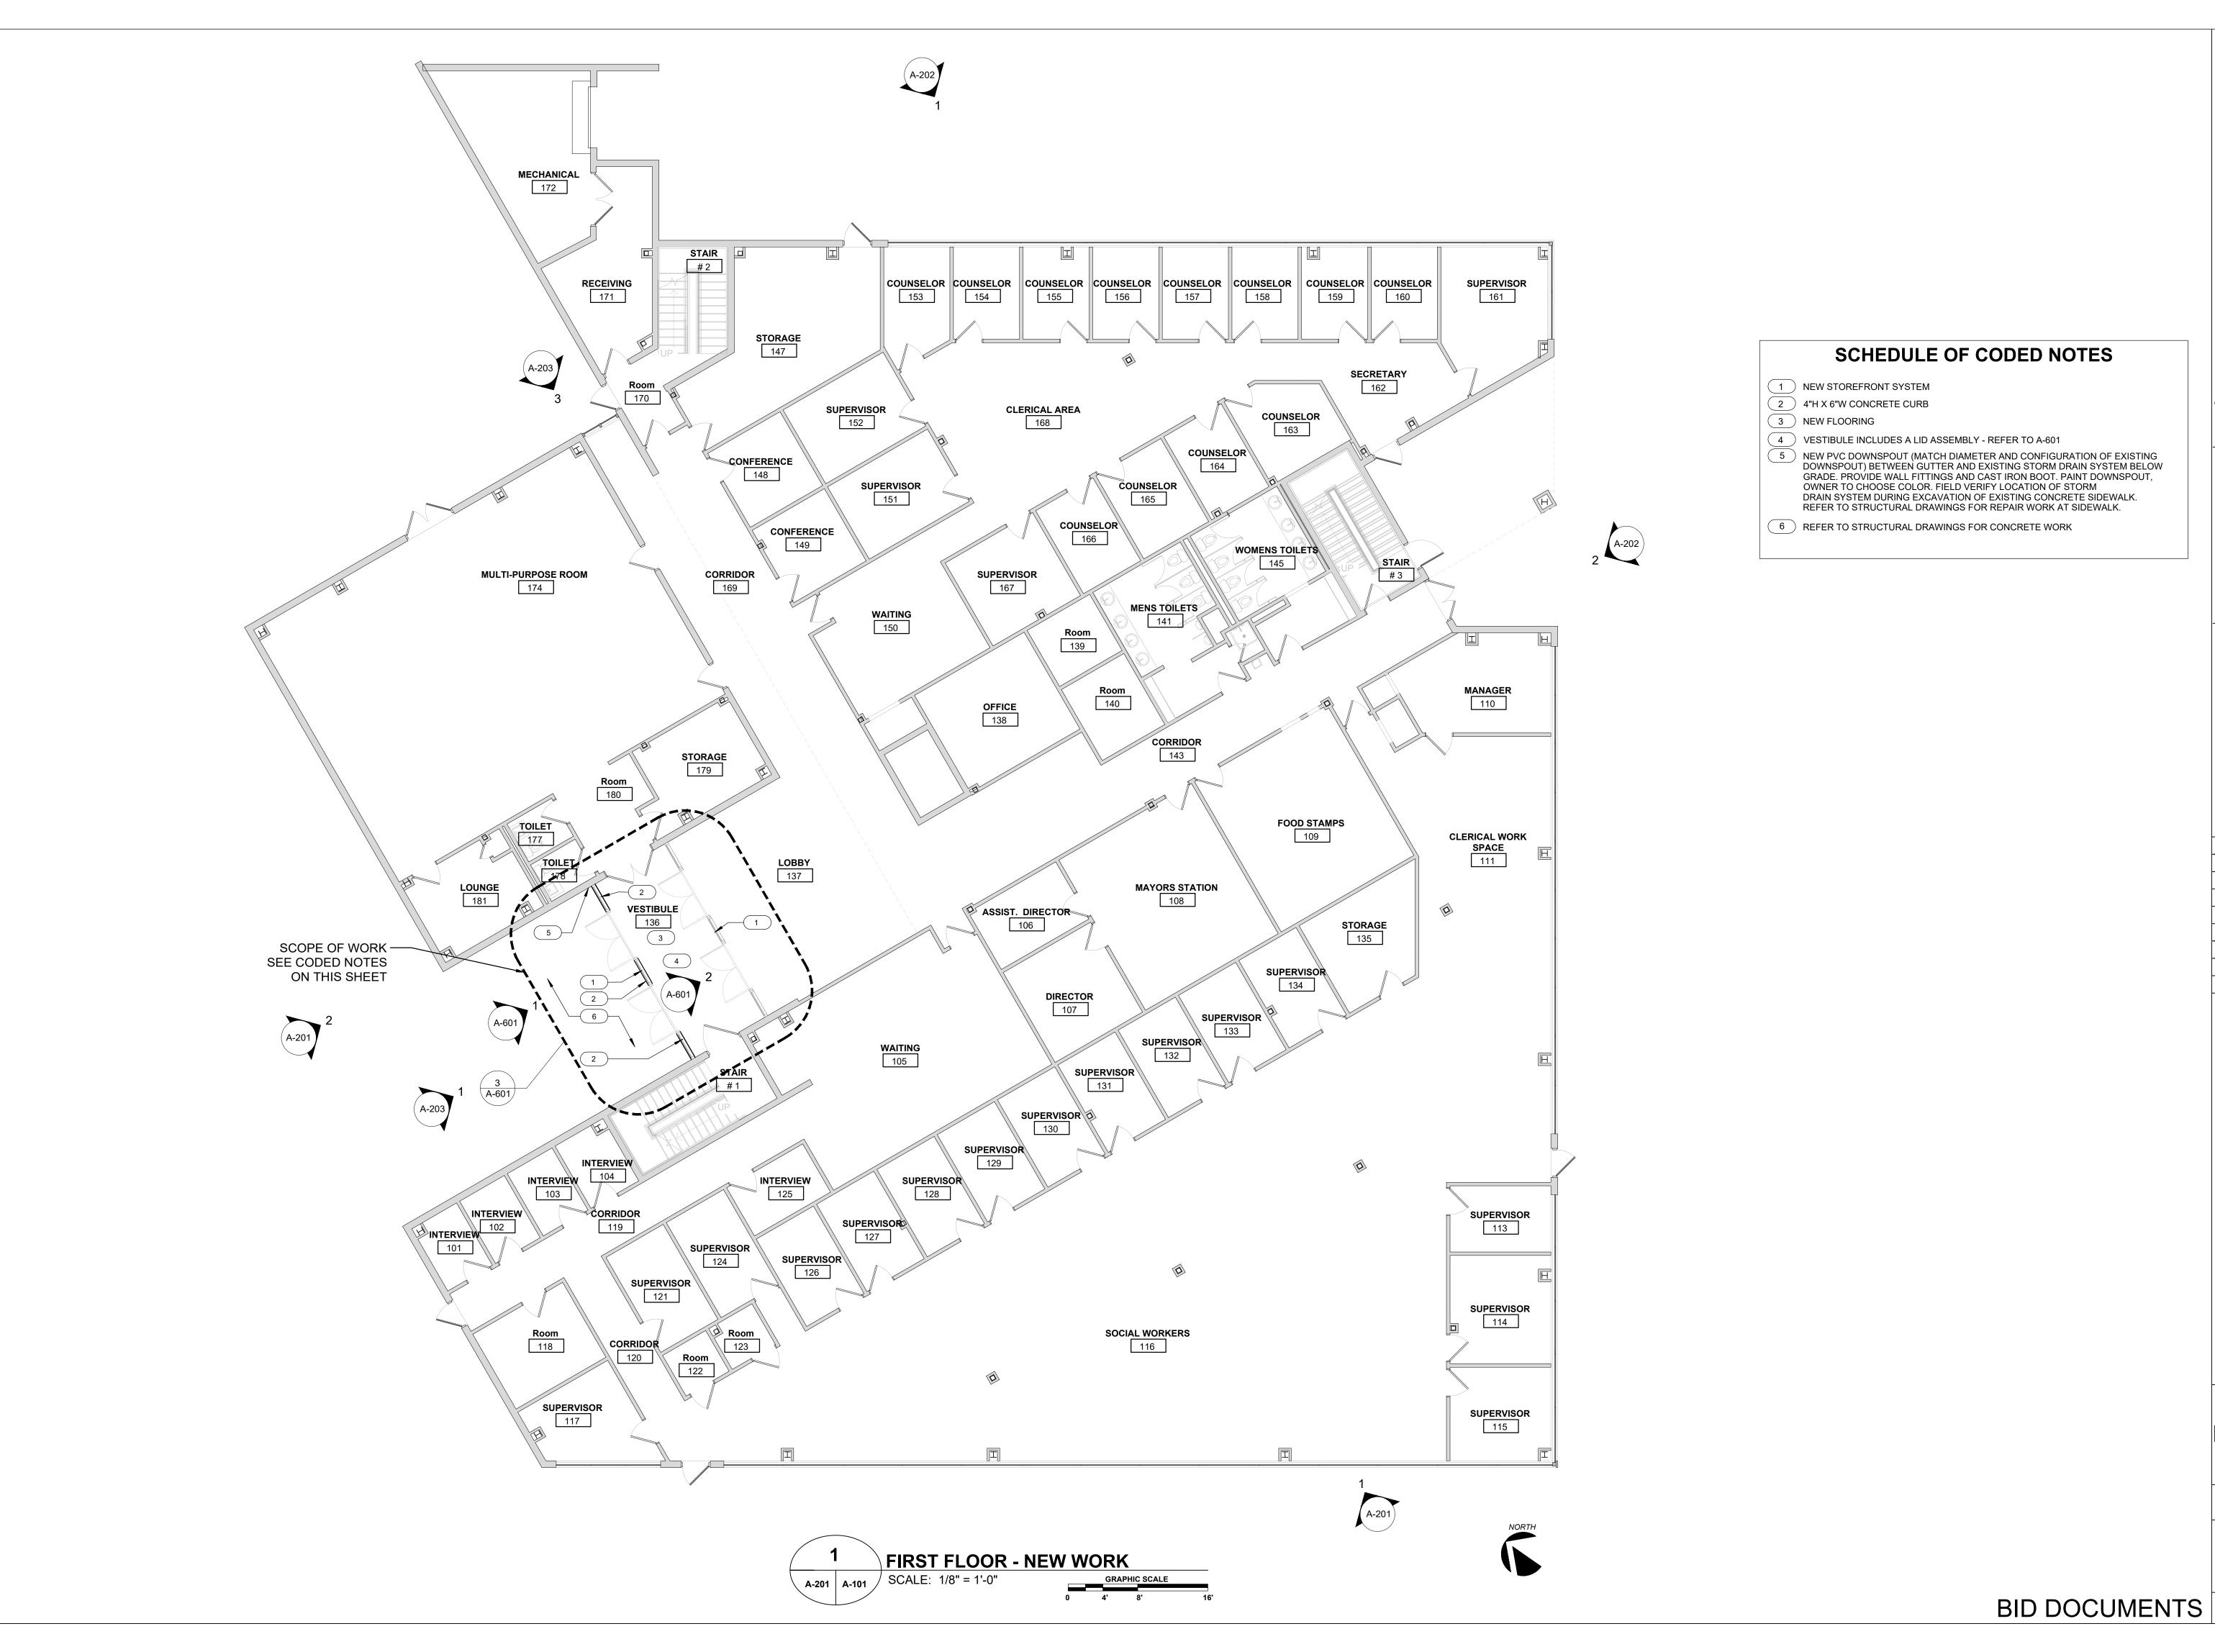



Maryland 21228 p (410) 654-3790 www.primeeng.com

SEAL





CITY OF BALTIMORE DEPARTMENT OF **GENERAL SERVICES** DESIGN AND CONSTRUCTION DIVISION

REVISIONS DATE DESCRIPTION

PARK HEIGHTS NITY CENTER ROOF EMENT / WALL REP, COMMUNI REPLACE! / ENTRY

SHEET NAME

FIRST FLOOR **PLAN**

8/03/2022

SHEET A-101



PROVIDE NEW ROOF SYSTEM CONSISTING OF NEW 60 MIL FULLY ADHERED PVC MEMBRANE OVER COVERBOARD OVER POLYISOCYANURATE INSULATION (R-30) OVER EXISTING STEEL DECK.

EXISTING STRUCTURAL STEEL DECK IS SLOPED 1/4" PER FOOT. NEW ROOF INSULATION SHALL BE MINIMUM 4-1/2" THICKNESS EXCEPT AT CRICKETS, CURBS,AND OTHER ROOF PENETRATIONS



EXISTING STANDING SEAM ROOF TO REMAIN (OUT OF SCOPE)



NEW SADDLES AND CRICKETS



NEW DRAIN SUMPS



INDICATES ROOF SLOPE ON THE STRUCTURAL DECK



→ INDICATES CHAIN LINK FENCE

ABBREVIATION LEGEND:

EF EXHAUST FAN/HOOD

HS HOT STACK

RD ROOF DRAIN

RTU ROOF TOP UNIT SC THRU-WALL SCUPPER

VTR VENT THRU ROOF

SLH SERVICE LINE HOUSING

CONSULTANTS

Suite 300 | Baltimore, Maryland 21228 p (410) 654-3790 www.primeeng.com

SEAL





CITY OF BALTIMORE DEPARTMENT OF **GENERAL SERVICES** DESIGN AND CONSTRUCTION

DIVISION

SCHEDULE OF CODED NOTES

7 NEW STEP FLASHING AND SEALANT PER DETAIL 3/A506.

RESET GAS LINE. CLEAN/REMOVE RUST AND PAINT PER SPECIFICATIONS. PROVIDE NEW PIPE SUPPORTS PER DETAIL 3/A-504.

9 NEW ROOF DECK AT DEMOLISHED ROOF HATCH. SEE DETAIL 3/A-503.

FIELD VERIFY CONDUIT THROUGH ROOF LOCATIONS AND INSTALL CURBS AND SERVICE LINE HOUSING ACCORDINGLY. RECONNECT SERVICE LINES AND RESTORE TO WORKING CONDITION. SEE DETAIL 4/A-501.

11 REINSTALL CHAIN-LINK FENCING.

13 NEW SEALANT AT EXISTING SKYLIGHTS.

INFILL ABOVE THE STAIR TOWER ROOF FLUSH WITH PERIMETER EDGE WITH NEW ROOF SYSTEM AND INSULATION. SLOPE PER PLAN LAYOUT. SEE DETAIL 2/A-505.

INFILL ABOVE THE ELEVATOR ROOF FLUSH WITH PERIMETER EDGE WITH NEW ROOF SYSTEM AND INSULATION. SLOPE PER PLAN LAYOUT. SIMILAR TO DETAIL

23 INFILL ABANDONED THROUGH-WALL SCUPPER W/ MASONRY (MATCH EXISTING). PLUMB CONDENSATE LINE FROM RTU TO ROOF DRAIN IN CLOSE PROXIMITY - 7 LOCATIONS. PROVIDE PIPE SUPPORT PER DETAIL 3/A-504.

REVISIONS DATE DESCRIPTION

COMMUN REPLACE / ENTRY

SHEET NAME

ROOF PLAN NEW WORK

8/03/2022

SHEET A-141



WALKWAY PADS

ABBREVIATION LEGEND:

- EF EXHAUST FAN/HOOD
- HS HOT STACK
- RD ROOF DRAIN
- RTU ROOF TOP UNIT
- SC THRU-WALL SCUPPER VTR VENT THRU ROOF
- SLH SERVICE LINE HOUSING


SCHEDULE OF CODED NOTES

1A WALKWAY PADS - REFER TO DETAIL 2/A-504.

5521 Research Park Drive | Suite 300 | Baltimore, Maryland 21228 p (410) 654-3790 www.primeeng.com

SEAL



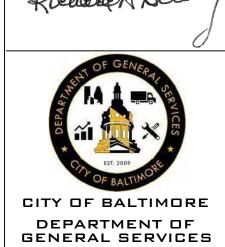

DESIGN AND CONSTRUCTION DIVISION

REVISIONS

COMMUNITY CEN COMMUNITY CEN REPLACEMENT / / ENTRY 3939 REISTERSTOWN RD. BALTIMO CONTRACT NO. GS 21822

SHEET NAME

WALKWAY LAYOUT **PLAN**

8/03/2022

SHEET A-142

18 OF 30

BID DOCUMENTS

ALL EXTERIOR CONCRETE MASONRY TO RECEIVE SPECIFIED COATS OF WATER REPELLENT.

ABBREVIATION LEGEND: CJ CLEAN AND PREP JOINT SUBSTRATES FOR NEW BACKER ROD AND SEALANT.

Suite 300 | Baltimore, Maryland 21228 p (410) 654-3790 www.primeeng.com

CONSULTANTS

SCHEDULE OF CODED NOTES


- 14 NEW GLAZING BEADS AND SEALANT (TYP.)
- 15 NEW BACKER RODS AND SEALANT AT ALL EXISTING MASONRY CONTROL JOINTS.




CITY OF BALTIMORE

DEPARTMENT OF GENERAL SERVICES

DESIGN AND CONSTRUCTION DIVISION

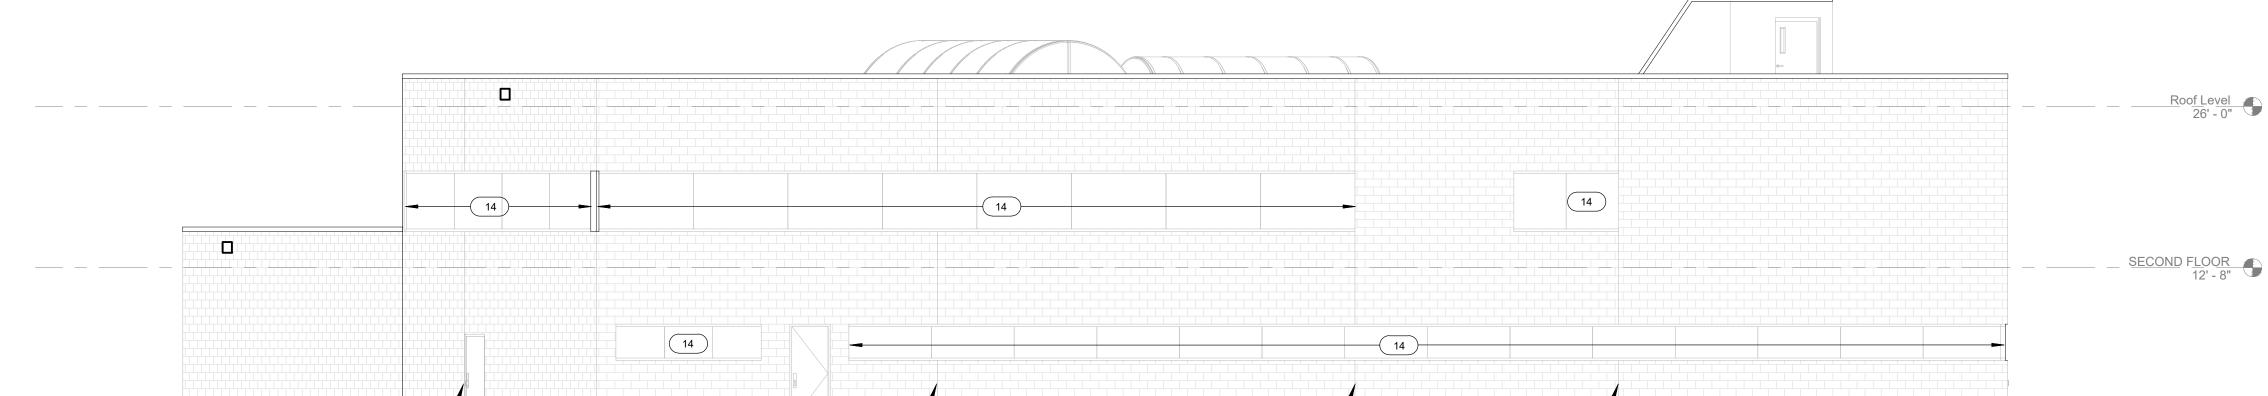

_____ CJ

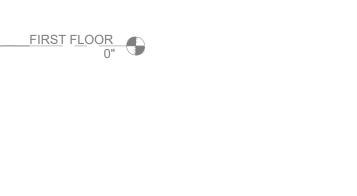




NOTE

14

PLEXIGLASS PANELS HAVE BEEN INSTALLED AT THE EXTERIOR OVER THE EXISTING WINDOWS. PLEXIGLASS PANELS ARE TO BE REUSED AND REINSTALLED IN THEIR PRESENT LOCATIONS AFTER REPAIR WORK HAS BEEN COMPLETED.

Roof Level 26' - 0"

FIRST FLOOR 0"

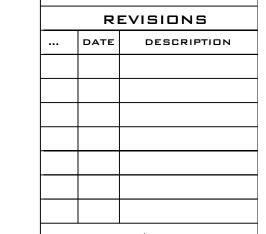

COMMUNITY CENTER ROOF
REPLACEMENT / WALL REPAIR
F ENTRY
3939 REISTERSTOWN RD. BALTIMORE, MD 21215
CONTRACT NO. GS 21822

SHEET NAME

ELEVATIONS NEW WORK

8/03/2022

SHEET A-201

NORTH ELEVATION NEW WORK SCALE: 1/8" = 1'-0"

□ sc

BID DOCUMENTS

19 **o**f 30

CONSULTANTS GENERAL NOTES ALL EXTERIOR CONCRETE MASONRY TO RECEIVE SPECIFIED COATS OF WATER Suite 300 | Baltimore, Maryland 21228 p (410) 654-3790 ABBREVIATION LEGEND: www.primeeng.com CJ CLEAN AND PREP JOINT SUBSTRATES FOR NEW BACKER ROD AND SEALANT.

SCHEDULE OF CODED NOTES

14 NEW GLAZING BEADS AND SEALANT (TYP.)


NOTE


PLEXIGLASS PANELS HAVE BEEN INSTALLED AT THE EXTERIOR OVER THE EXISTING WINDOWS.

PLEXIGLASS PANELS ARE TO BE REUSED AND REINSTALLED IN THEIR PRESENT LOCATIONS AFTER REPAIR WORK HAS BEEN COMPLETED.

FIRST FLOOR 0"

- 15 NEW BACKER RODS AND SEALANT AT ALL EXISTING MASONRY CONTROL JOINTS
- NEW STEEL LINTEL (ABOVE DOOR) W/ SAME CONFIGURATION/SHAPE AND NEW FLASHINGS. NEW MASONRY TO MATCH REMOVED PORTION.

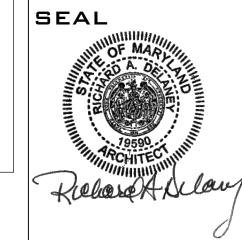

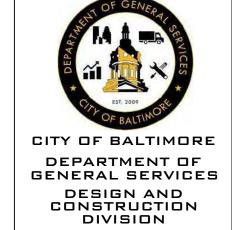

REVISIONS DATE DESCRIPTION

COMMUNITY CENTER ROOF

REPLACEMENT / WALL REPAIR

Y ENTRY

S939 REISTERSTOWN RD. BALTIMORE, MD 21215

CONTRACT NO. GS 21822

SHEET NAME

ELEVATIONS NEW WORK

8/03/2022


SHEET **A-202**

20 OF 30

BID DOCUMENTS

SOUTH ELEVATION NEW WORK

_____ CJ

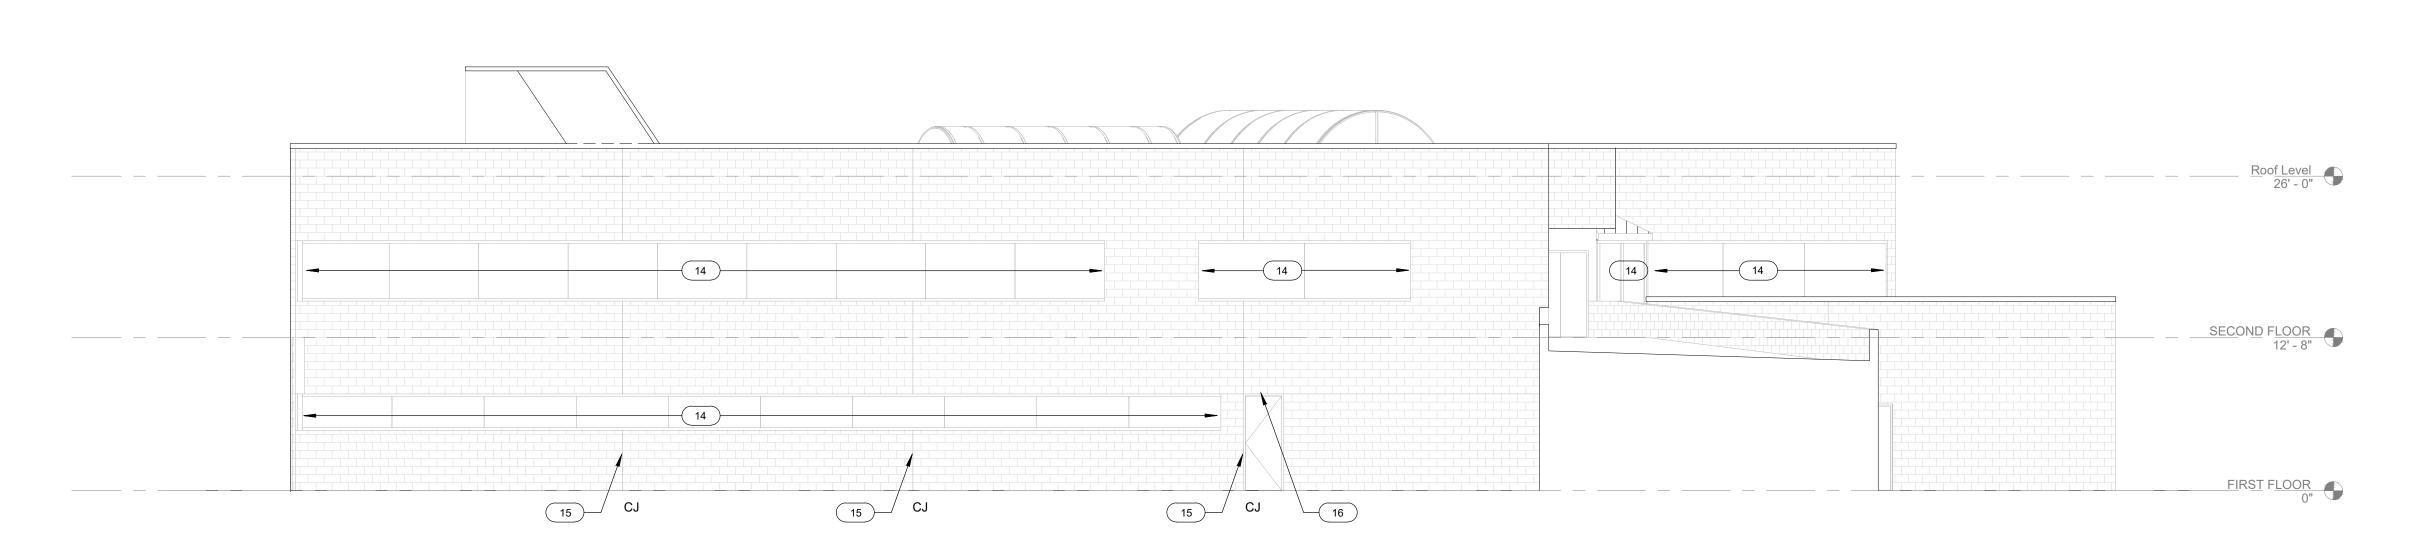

EAST ELEVATION NEW WORK A-202 SCALE: 1/8" = 1'-0"


Roof Level 26' - 0" 14 14 14 SECOND FLOOR 12' - 8" **—** 14 — 14

A-202 SCALE: 1/8" = 1'-0"

15 CJ

15 CJ

16

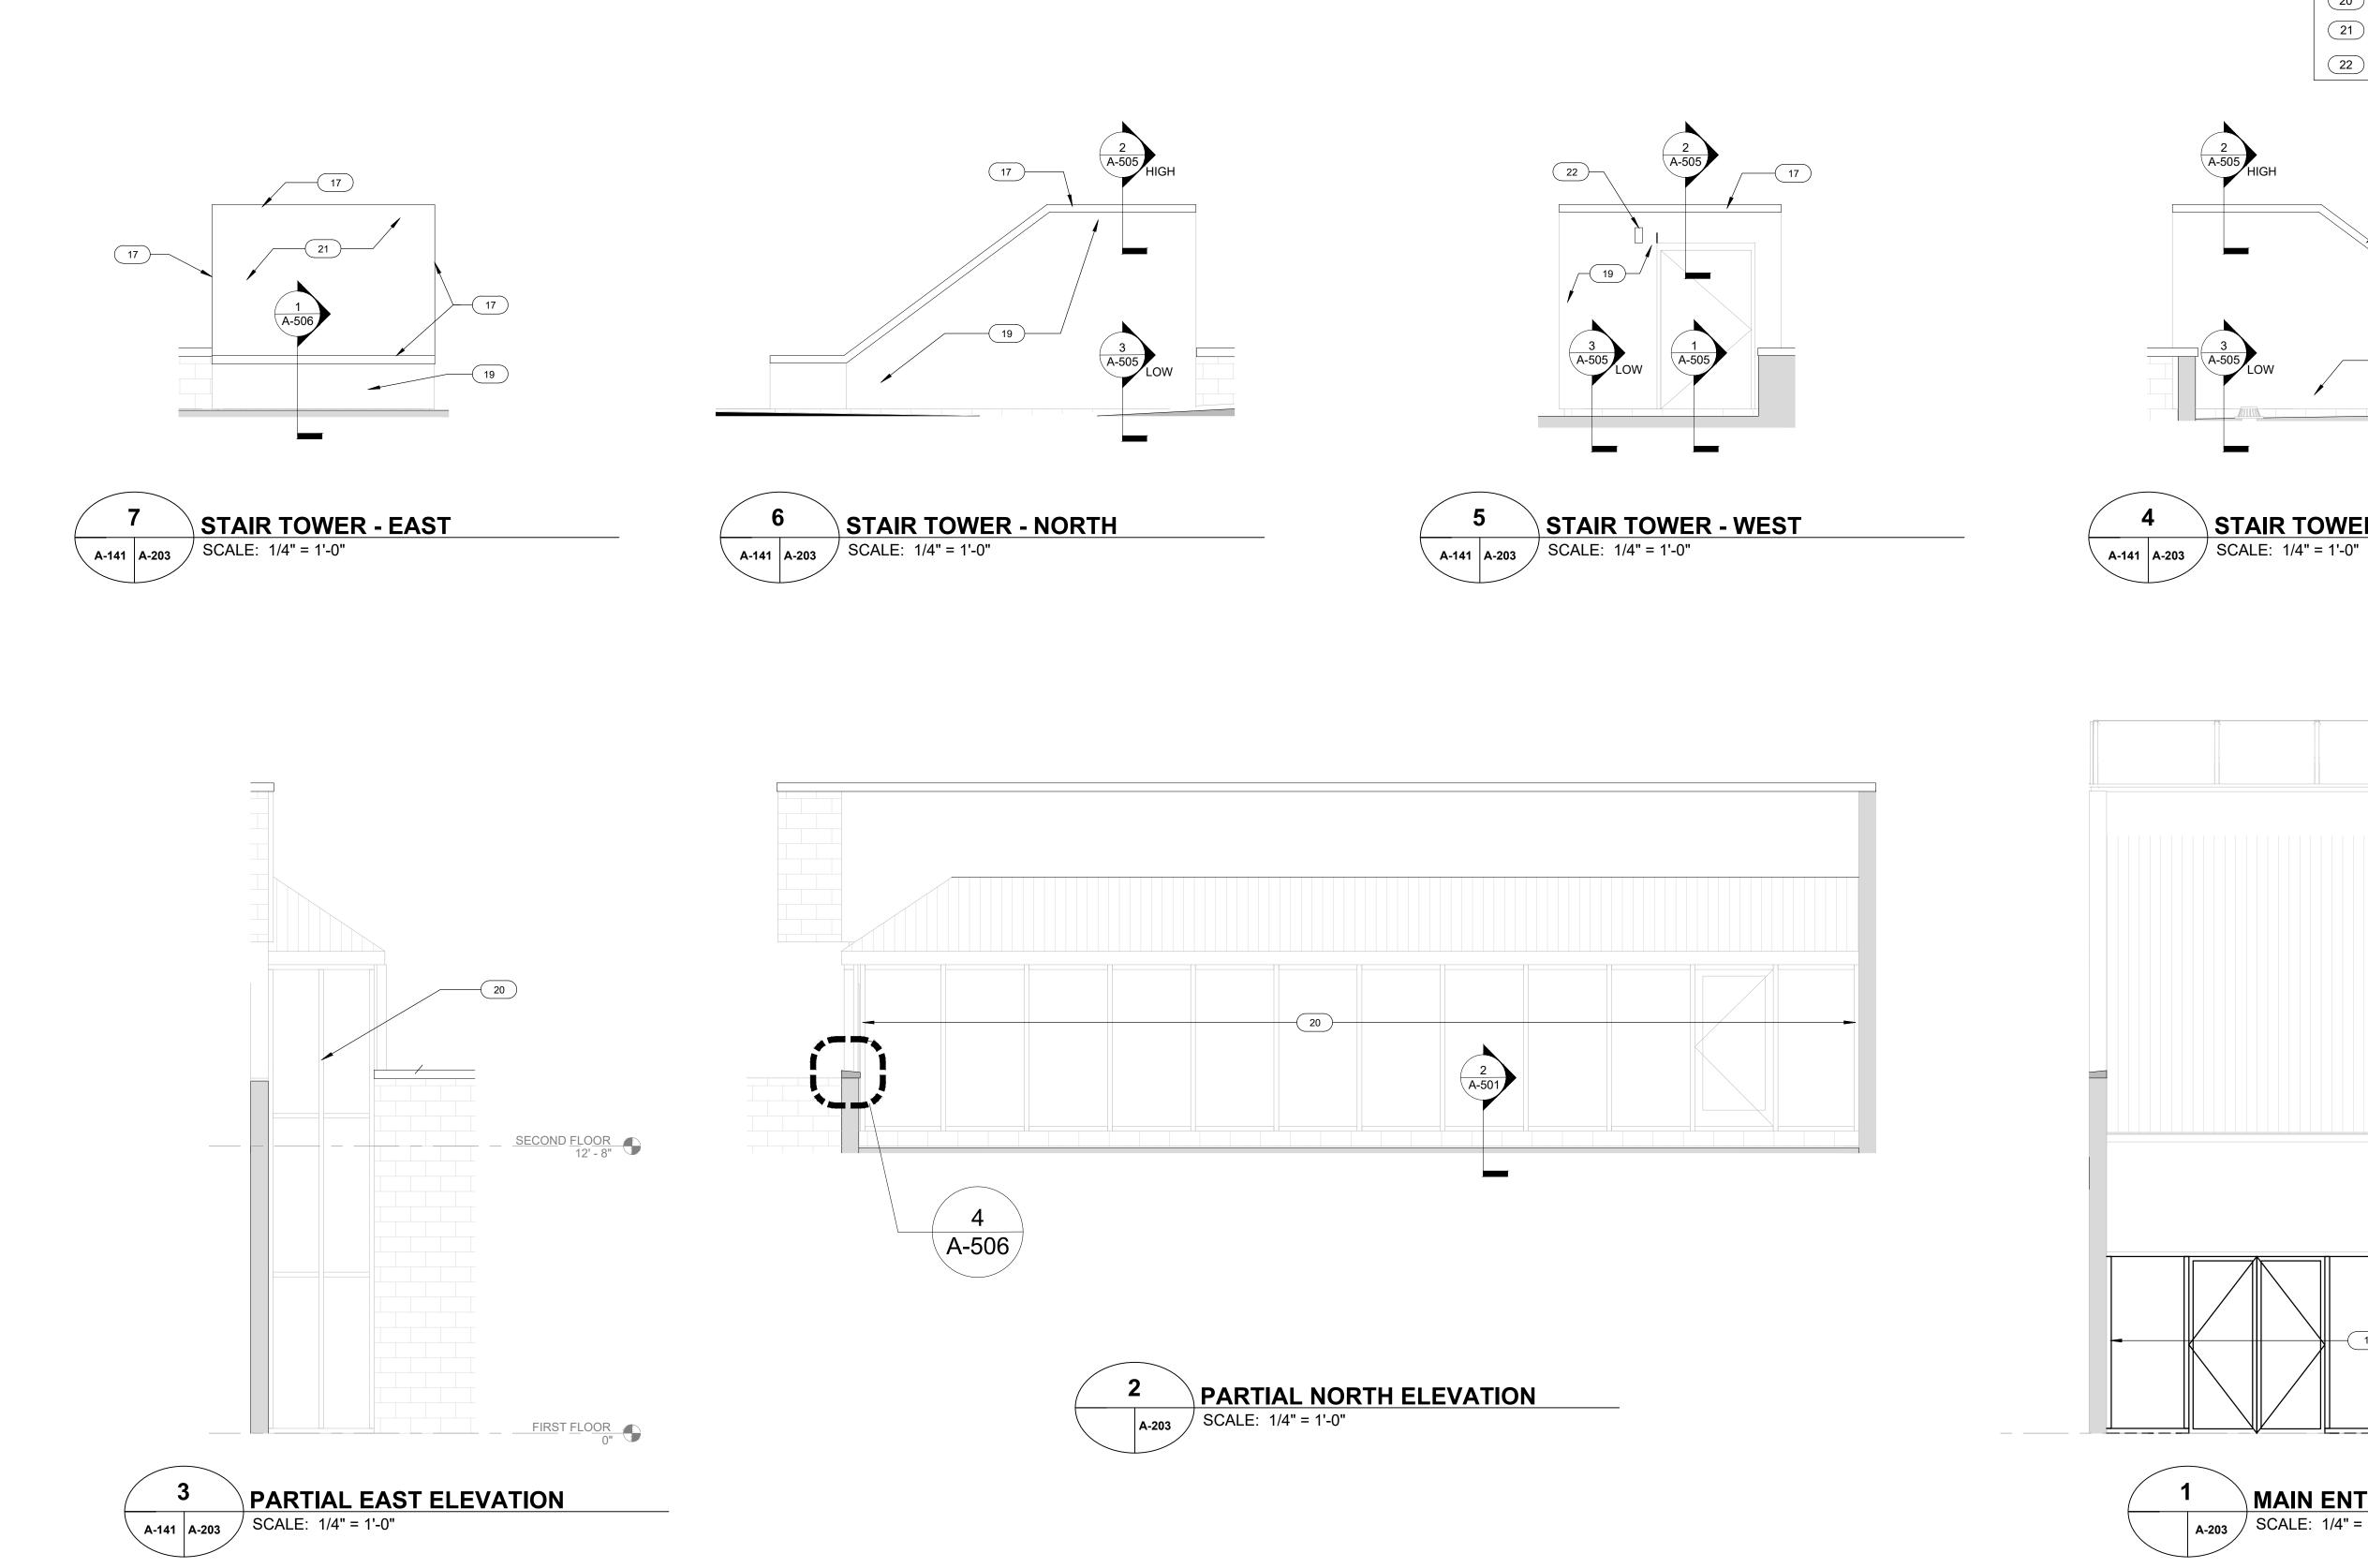

CLEAN ALL CONCRETE MASONRY TO REMOVE DIRT, STAINING, AND EFFLORESCENCE, EXTERIOR AND INTERIOR.

NEW EIFS AT STAIR TOWER ROOF.



Suite 300 | Baltimore, Maryland 21228 p (410) 654-3790 www.primeeng.com

SCHEDULE OF CODED NOTES

NEW STOREFRONT SYSTEM INCLUDING DOORS AND THRESHOLDS. SEE SHEET A/601.

17 NEW DRIP EDGE. SEE DETAIL 2/A-505.

19 NEW EIFS WALL FINISH.

STAIR TOWER - SOUTH


MAIN ENTRY ELEVATION

A-203 SCALE: 1/4" = 1'-0"

20 NEW BACKER RODS AND SEALANTS AT TRANSLUCENT WALL PANELS.

INFILL ABOVE THE STAIR TOWER ROOF FLUSH WITH PERIMETER EDGE WITH NEW ROOF SYSTEM. SEE DETAIL 2/A-505

PROVIDE NEW LIGHT FIXTURE. SEE DETAIL 2/A-506.

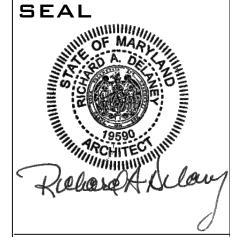



CITY OF BALTIMORE DEPARTMENT OF GENERAL SERVICES DESIGN AND CONSTRUCTION DIVISION

REVISIONS

COMMUNITY CENTER ROOF

REPLACEMENT / WALL REPAIR

F ENTRY

3939 REISTERSTOWN RD. BALTIMORE, MD 21215

CONTRACT NO. GS 21822

SHEET NAME


ELEVATIONS NEW WORK

8/03/2022


SHEET A-203


21 OF 30

BID DOCUMENTS

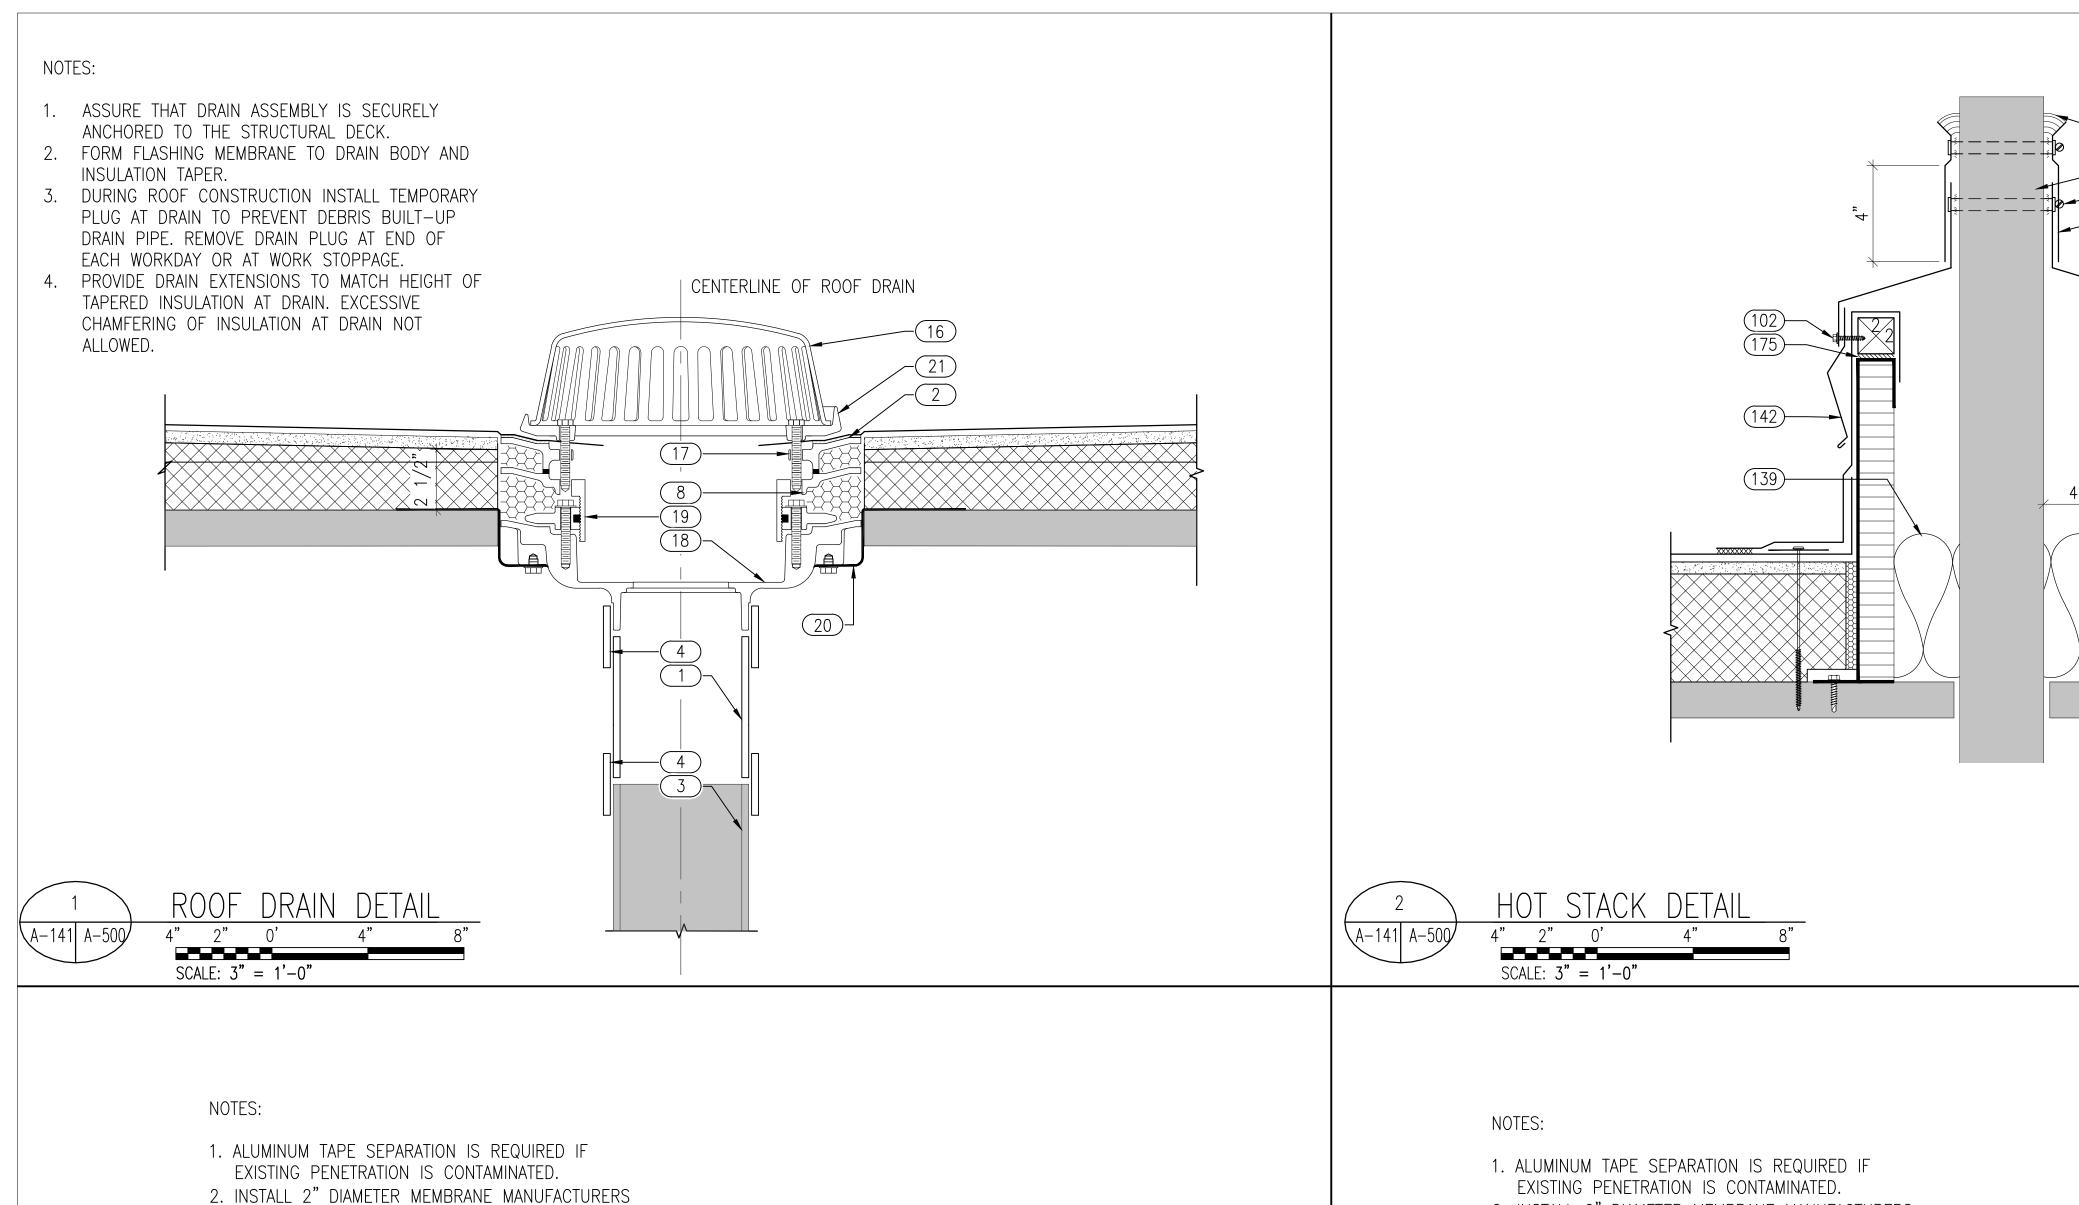


2. INSTALL 2" DIAMETER MEMBRANE MANUFACTURERS APPROVED DISCS/PLATES. MAINTAIN 3" O.C. MAXIMUM SPACING BETWEEN FASTENERS.

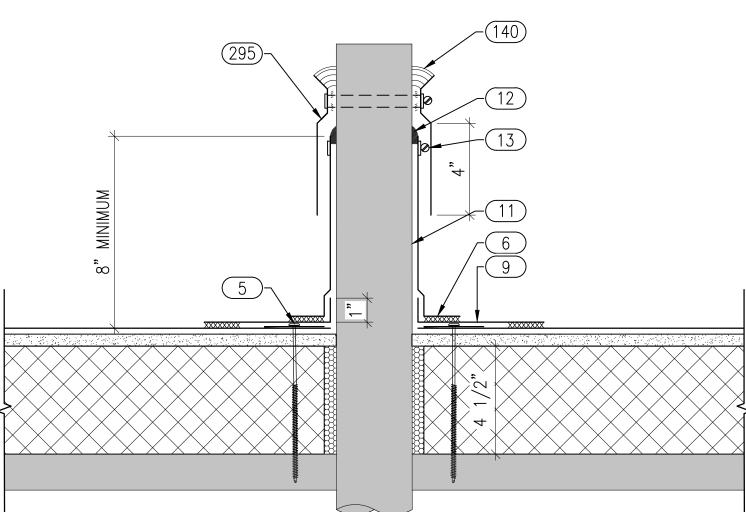

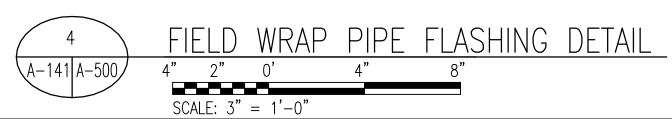



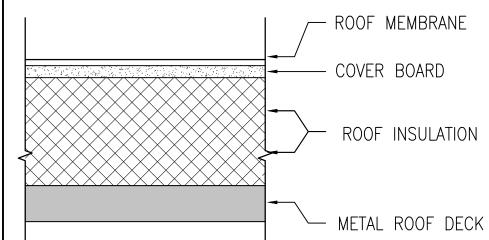

AND MODIFY AS INDICATED AND SPECIFIED

1/2" SPRAY FOAM INSULATION

PLYWOOD

KEYNOTES:

6 HOT AIR WELD

(17) STATIC EXTENSION

20 DECK PLATE

(18) NEW ROOF DRAIN BOWL

(21) NEW CLAMPING RING

(139) MINERAL FIBER INSULATION

2 PER SIDE

175 FOAM GASKET 177 NEW CURB

WATERTIGHT

294 EXISTING HOT STACK

(295) STAINLESS STEEL STORM COLLAR

12 SEALANT

(1) NEW PIPING AS REQUIRED

2 WATER CUT-OFF MASTIC 3 EXISTING STORM LEADER

(4) COUPLING AS REQUIRED

9) MEMBRANE TARGET PATCH 10 PRE-MOLDED PIPE BOOT (11) EXISTING PIPE PENETRATION

5 ANCHOR PLATES FASTENED 6" O.C.

13 STAINLESS STEEL CLAMPING RING

(16) NEW ROOF DRAIN DOME STRAINER

(19) ADJUSTABLE DRAIN EXTENSION

8 INFILL VOIDS AROUND NEW DRAIN WITH SPRAY FOAM

102) FASTENERS WITH SEALING WASHERS 16" O.C. MINIMUM

140 TEMPERATURE RATED ELASTROMERIC SEALANT

141 STAINLESS STEEL DRAWBAND


142 24 GAUGE STAINLESS STEEL COUNTERFLASHING

(293) 22 GAUGE STAINLESS STEEL CURB COVER SOLDERED

WOOD BLOCKING

Suite 300 | Baltimore, Maryland 21228 p (410) 654-3790 www.primeeng.com

CONSULTANTS

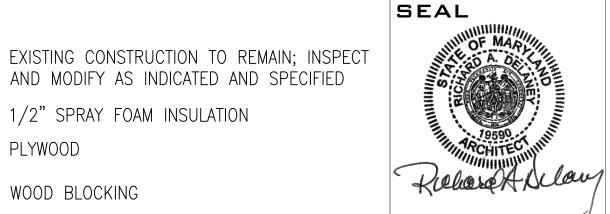

CITY OF BALTIMORE DEPARTMENT OF GENERAL SERVICES DESIGN AND CONSTRUCTION DIVISION

REVISIONS

REPAIR COMTRACTOR

SHEET NAME

TYPICAL DETAILS

8/03/2022

SHEET

A-500

22 **OF** 30

BID DOCUMENTS

A-141 A-500


PRE-MOLDED PIPE FLASHING DETAIL 4" 2" 0' 4"


APPROVED DISCS/PLATES. MAINTAIN 3" O.C.


2 1/2"


1 1/2"


MAXIMUM SPACING BETWEEN FASTENERS.

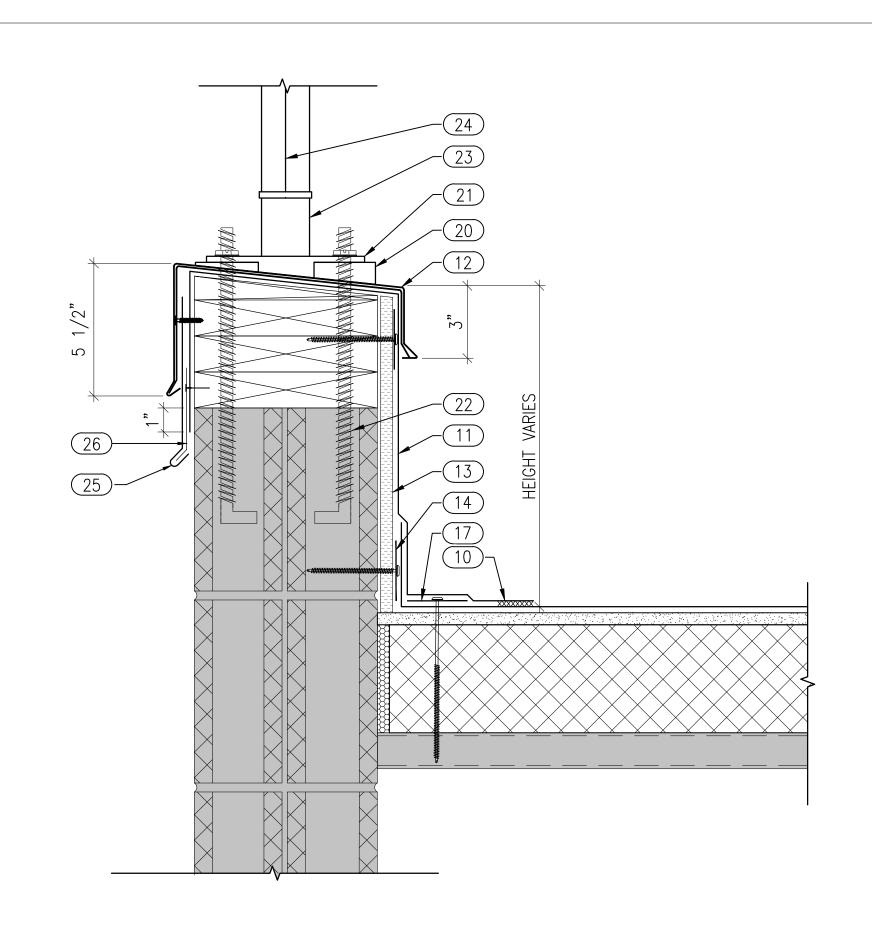


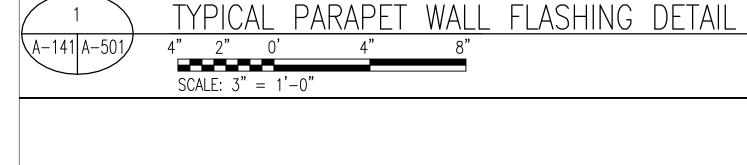

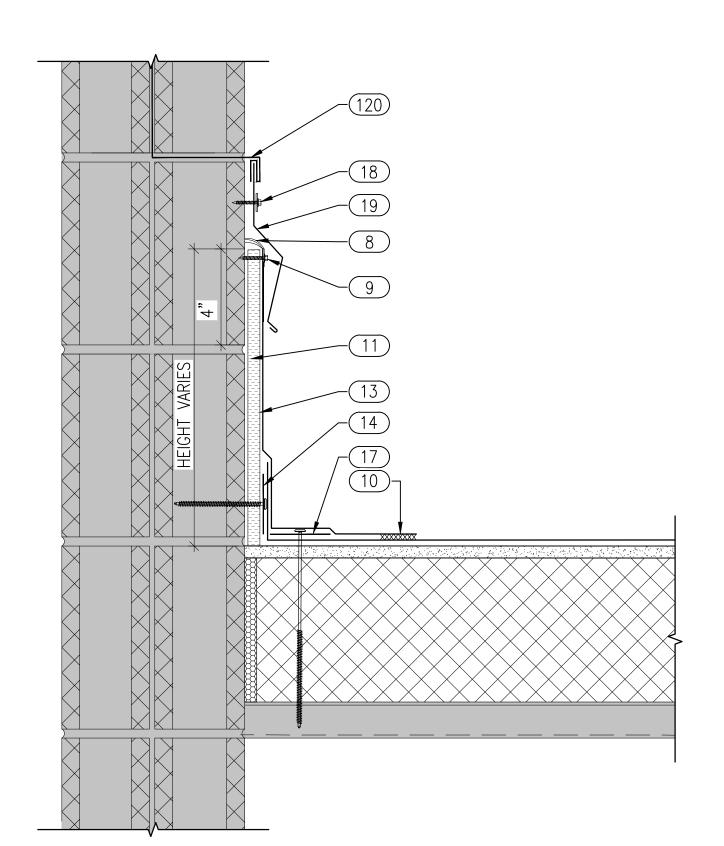

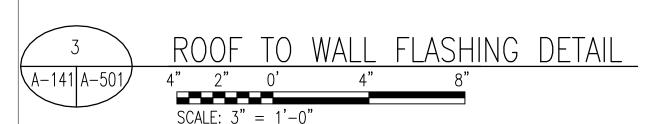

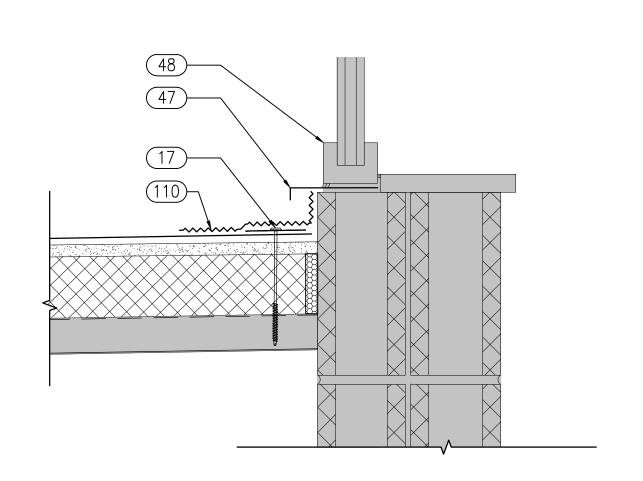

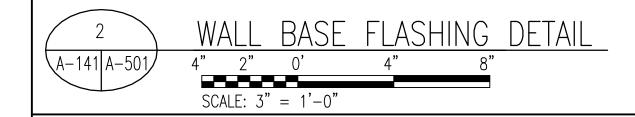



PRE-MANUFACTURED SERVICE LINE HOUSING SPECIFICATIONS

- 20-YEAR WARRANTY ACCOMODATING MULTIPLE PENETRATIONS
- CONSTRUCTED OF HEAVY GAUGE FACTORY FINISHED WELDED ALUMINUM WITH GASKETS AND STAINLESS STEEL HARDWARE
- UNIT HAS A THREE PIECE CONFIGURATION, CONSISTING OF A REMOVABLE
- VANDAL RESISTANT LID, MIDDLE HOUSING AND WIDE FLANGED CURB
- EXIT SEALS ARE OF AN ALUMINUM OR STAINLESS STEEL CONFIGURATION
- ALL PENETRATIONS EXITING THE HOUSING MUST BE SUPPORTED WITHIN 12
- INCHES AFTER EXITING

NOTES:

- BASIS OF DESIGN:
- AWI MEDIUM VAULT
- MANUFACTURED BY ROOF PENETRATION HOUSING, LLC

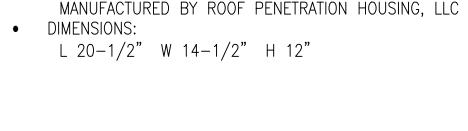


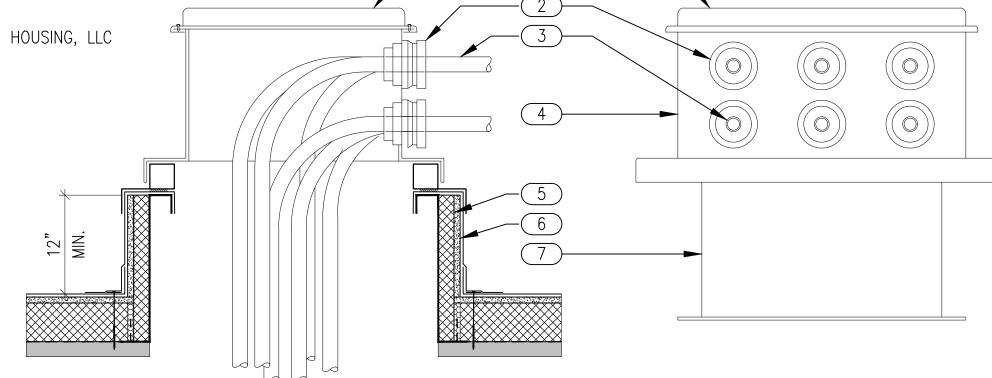


<u>SECTION</u>

1. FLASH CURB SIMILAR TO 3/A-502.

2. PROVIDE (4) FOUR EXTRA EXIT SEALS PER HOUSING AS ATTIC STOCK. (2) 5000 SERIES EXIT SEALS AND (2) 6000 SERIES EXIT SEALS.

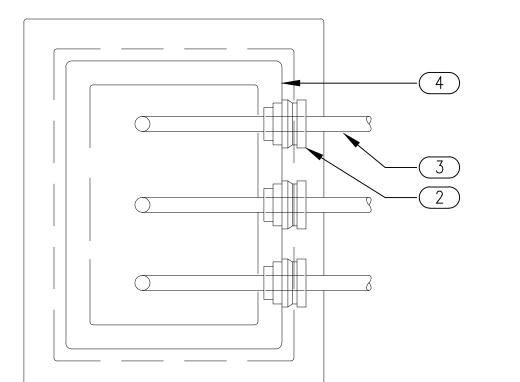

<u>PLAN</u>

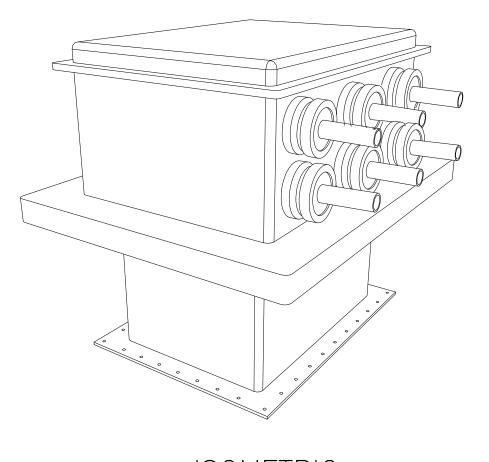


ELEVATION

ISOMETRIC

SERVICE LINE HOUSING DETAIL A-501 A-501 SCALE: NOT TO SCALE

GRAPHIC LEGEND:

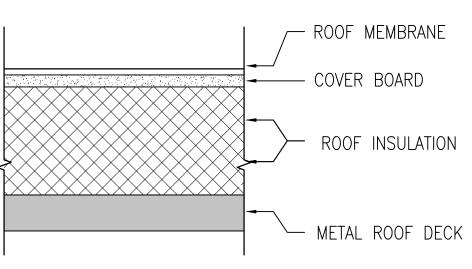



www.primeeng.com

CONSULTANTS

SEAL



EXISTING CONSTRUCTION TO REMAIN; INSPECT AND MODIFY AS INDICATED AND SPECIFIED 1/2" SPRAY FOAM INSULATION

PLYWOOD

WOOD BLOCKING

CITY OF BALTIMORE DEPARTMENT OF GENERAL SERVICES DESIGN AND CONSTRUCTION DIVISION

KEYNOTES:

- (1) MATCHING WIND—RATED ALUMINUM COVER 2 EXIT SEAL
- 3 EXISTING CONDUIT OR REFRIGERANT PIPE, MODIFY PIPE AS REQUIRED
- (4) PRE-FABRICATED SERVICE LINE HOUSING
- 5 1 1/2" RIGID INSULATION ADHERED TO HOUSING WALL 6 1/2" COVER BOARD ADHERED TO RIGID INSULATION
- 7 ALUMINUM CURB 16" HIGH MINIMUM INSTALL PER MANUFACTURER'S INSTALLATION INSTRUCTIONS
- (8) SEALANT
- 9 TERMINATION BAR FASTENED 12" O.C.

SQUARE FEET.

- 10 HOT AIR WELD
 11 ROOF MEMBRANE FLASHING
- 12 COPING CAP SYSTEM
- 1/2" STRUCTURAL CEMENT BOARD. (14) FASTENERS AND PLATES TO SECURE CEMENT BOARD TO EXISTING WALL. MINIMUM OF 1 FASTENER PER 2
- ANCHOR PLATES FASTENED 6" O.C.
- FASTENERS WITH SEALING WASHERS 12" O.C.
- (19) 24 GAUGE STAINLESS STEEL SURFACE MOUNTED COUNTERFLASHING

 (20) FABRICATE STAINLESS STEEL BAR STOCK SHIMS
- FOR LEVELING STEEL PLATE.
- 21 EXISTING STAINLESS STEEL PLATE TO BE REINSTALLED.
- 22 EXISTING BOLTS TO REMAIN (TYP. OF 4)
- (23) EXISTING FENCE POSTS TO BE REINSTALLED. 24 EXISTING FENCE TO BE REINSTALLED.
- 25 PRE-FINISHED FASCIA EXTENDER FASTENED 12" O.C. FINISH TO MATCH COPING / EDGE METAL SYSTEM.
- 26 22 GAUGE GALVANIZED CLEAT FASTENED 12" O.C. (47) NEW METAL COUNTERFLASHING AT EXISTING WINDOW.
- (48) EXISTING WINDOW SYSTEM TO REMAIN.
- 110 LIQUID FLASHING.
- (120) EXISTING THRU-WALL FLASHING, MODIFY RECEIVER TO SECURE TO COUNTERFLASHING.

REVISIONS

CONTRACTOR

SHEET NAME


TYPICAL DETAILS

8/03/2022

SHEET


A-501

BID DOCUMENTS 23 OF 30

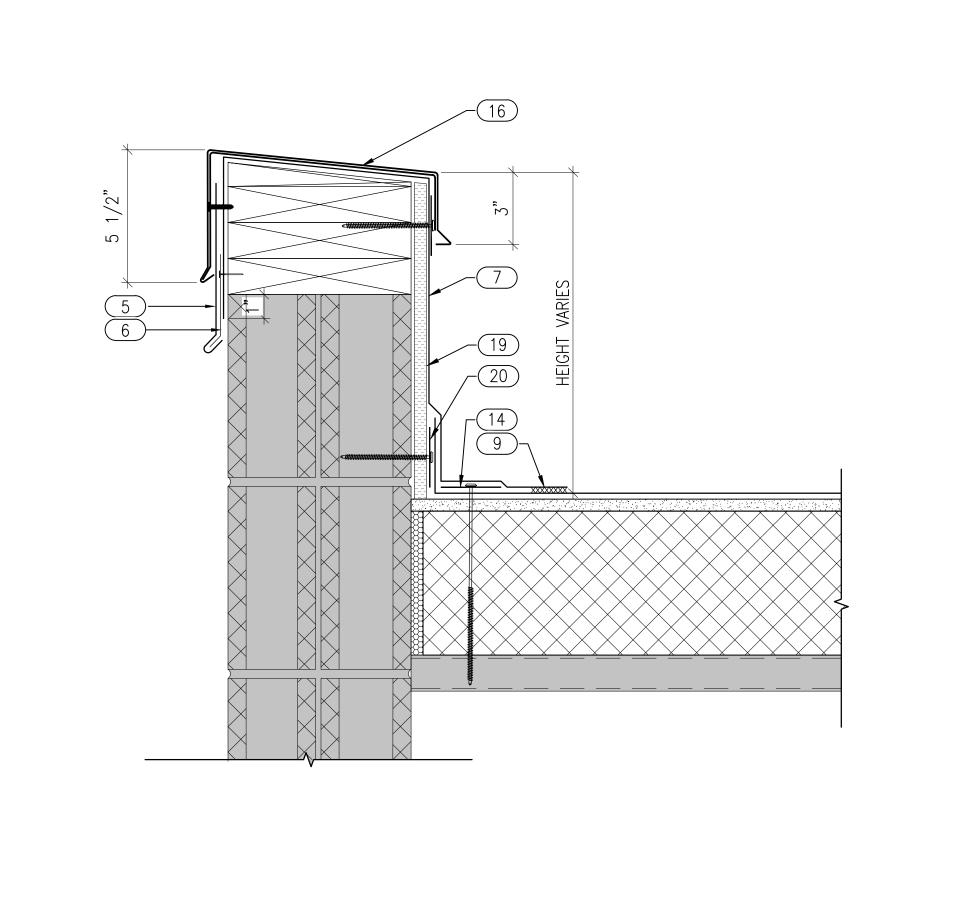


TYPICAL PARAPET WALL FLASHING DETAIL

SCALE: 3'' = 1'-0''

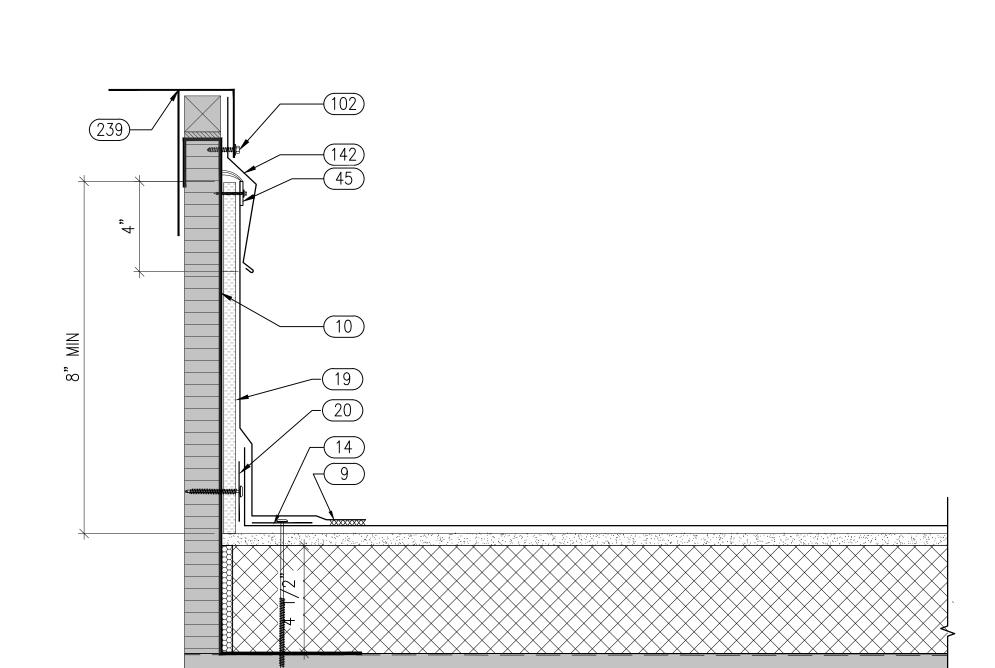


NON-REMOVABLE UNIT CURB FLASHING DETAIL

4" 2" 0' 4" 8"

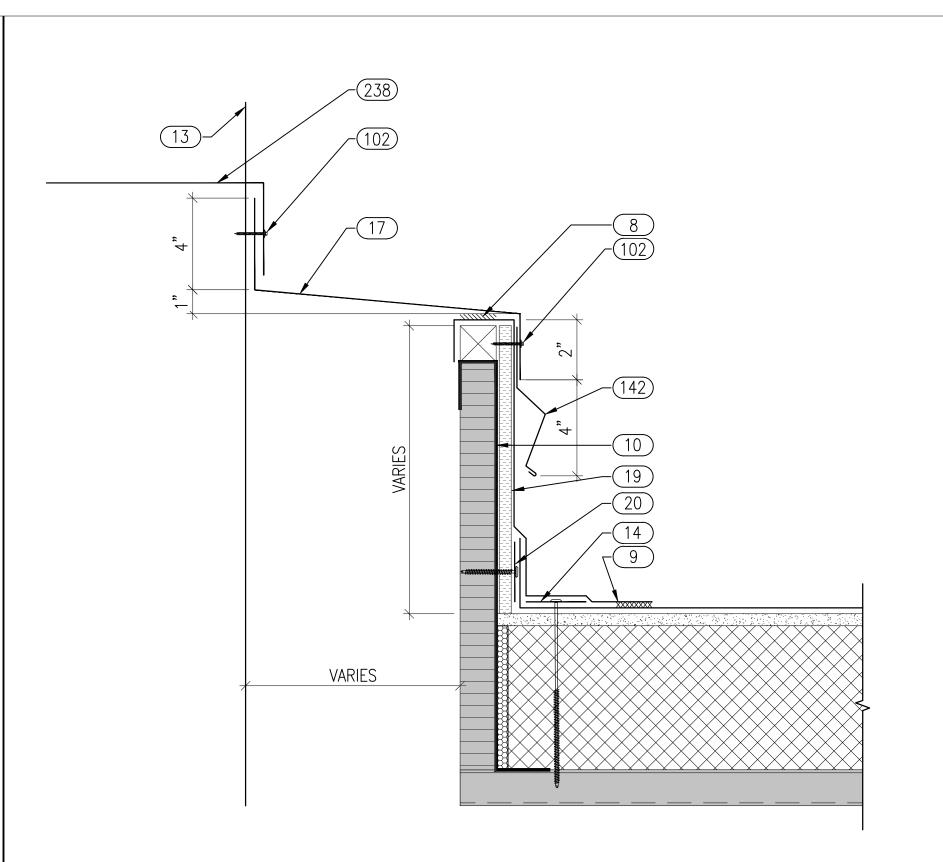

2 MECHANICAL CURB (RTU) FLASHING DETAIL
A-141 A-502 4" 2" 0' 4" 8"

SCALE: 3'' = 1'-0''

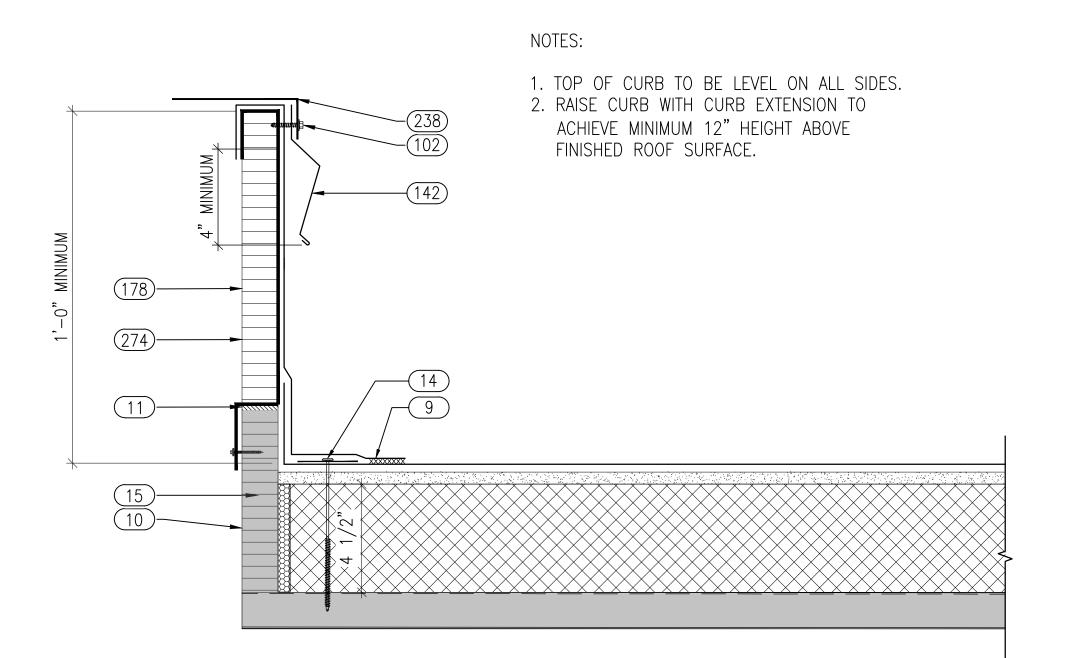


4 CURB EXTENSION DETAIL (OPTION)

A-141 A-502 4" 2" 0' 4" 8"

SCALE: NOT TO SCALE

GRAPHIC LEGEND:

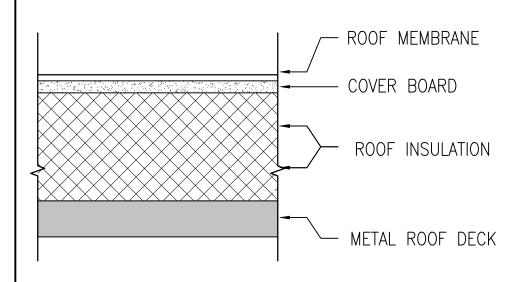

EXISTING CONSTRUCTION TO REMAIN; INSPECT AND MODIFY AS INDICATED AND SPECIFIED

WOOD BLOCKING


KEYNOTES:


- 5 PRE-FINISHED FASCIA EXTENDER FASTENED 12" O.C. FINISH TO MATCH COPING / EDGE METAL SYSTEM
- 6 22 GAUGE GALVANIZED CLEAT FASTENED 12" O.C.
- 7 ROOF MEMBRANE FLASHING.
- 8 FOAM GASKET.
- 9 HOT AIR WELD.
- 10 EXISTING CURB.
- 11) CURB EXTENSION.
- (12) NOT USED.
- (13) EXISTING ROOF PENETRATION.
- 14 FASTENERS AND PLATES 6" O.C.
- 15 REPLACE RIGID INSULATION ON CURB WALLS.
- (16) COPING CAP SYSTEM.
- 22 GAUGE STAINLESS STEEL CURB ADAPTER SOLDERED WATERTIGHT. USE STAINLESS STEEL RIVETS 2" O.C. FOR SEAMS PRIOR TO SOLDERING.
- (19) 1/2" STRUCTURAL CEMENT BOARDS.
- FASTENERS AND PLATES TO SECURE CEMENT BOARD TO EXISTING WALL. MINIMUM OF 1 FASTENER PER 2 SQUARE FEET.
- 21 NOT USED
- 45 TERMINATION BAR FASTENED 12" O.C.
- (102) STAINLESS STEEL SCREWS WITH SEALING WASHERS 16" O.C. MINIMUM 2 PER SIDE.
- (142) 24 GAUGE STAINLESS STEEL COUNTERFLASHING.
- 178 1 1/2" RIGID INSULATION.
- 238) CURB MOUNTED EQUIPMENT COVER.
- 239) EXISTING NON-REMOVABLE CURB MOUNTED EQUIPMENT COVER.
- 274) CURB EXTENSION.

CONSULTANTS

PRIME

5521 Research Park Drive Suite 300 | Baltimore, Maryland 21228 p (410) 654-3790 www.primeeng.com

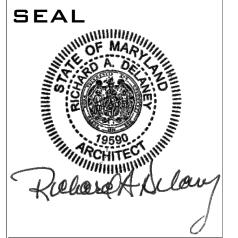

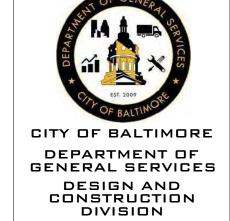

REVISIONS

D. DATE DESCRIPTION

E 5

COMMUNITY CENTER ROOF REPLACEMENT / WALL REP, / ENTRY
3939 REISTERSTOWN RD. BALTIMORE, MD 21


SHEET NAME


TYPICAL DETAILS

8/03/2022

SHEET A-502

BID DOCUMENTS 24 OF 30

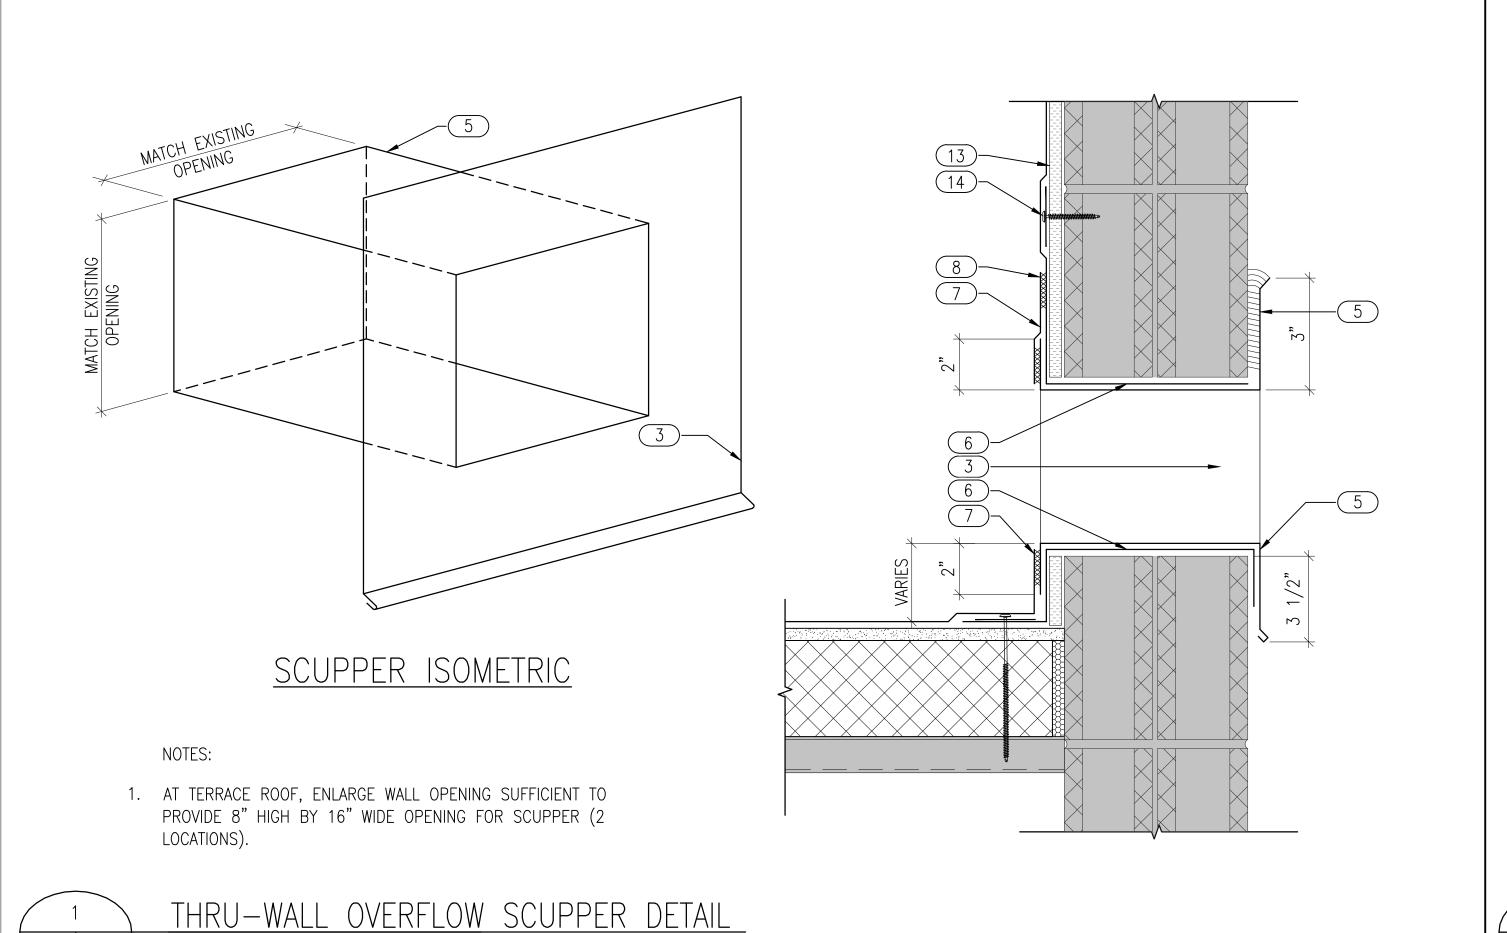

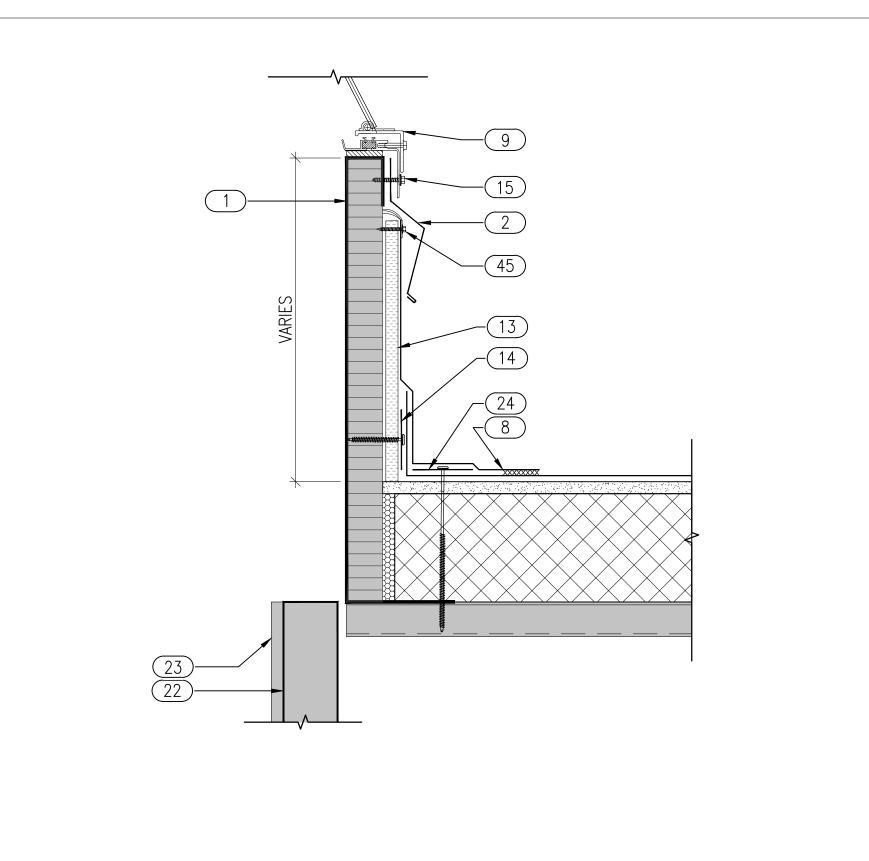

SKYLIGHT FLASHING DETAIL

SCALE: 3'' = 1'-0''

KEYNOTES:

EXISTING SKYLIGHT CURB TO REMAIN.

PLYWOOD

WOOD BLOCKING

GRAPHIC LEGEND:

24 GAUGE STAINLESS STEEL COUNTERFLASHING.

(5) 24 GA PRE-FINISHED GALVALUME SCUPPER CLOSURE FLANGE/TRIM WITH UV-RATED CONTINUOUS SEALANT AT PERIMETER. SET FLANGE IN FULL BED OF SEALANT. MATCH COPING CAP SYSTEM COLOR.

SCUPPER SLEEVE.

8) HOT AIR WELD.

(9) EXISTING SKYLIGHT.

13 1/2" STRUCTURAL CEMENT BOARD.

(14) FASTENERS AND PLATES TO SECURE CEMENT BOARD TO EXISTING WALL. MINIMUM OF 1 FASTENER PER 2 SQUARE FEET.

22 EXISTING GYPSUM WALL BOARD.

45 TERMINATION BAR FASTENED 12" O.C.

56 NEW DECKING

3 PVC COATED SCUPPER SLEEVE.

(6) LINE OPENING WITH MEMBRANE BEFORE INSTALLING

7 STRIP-IN END OF SLEEVE ALL AROUND ON ROOF SIDE WITH MEMBRANE FLASHING.

15 FASTENERS WITH SEALING WASHERS 16" O.C.


MINIMUM 2 PER SIDE.

23 EXISTING METAL STUD SHAFT WALL. 24 ANCHOR PLATES FASTENED 6" O.C.


57 EXISTING BAR JOIST/STRUCTURAL SUPPORT

METAL DECK MAX. SPAN G-90 GALVANIZED PLATE 0" TO 12" INTERMEDIATE OR WIDE RIB 5'-6" INTERMEDIATE OR WIDE RIB INTERMEDIATE OR WIDE RIB 1-1/2" 6'-6" 1-1/2" 7'-0" NOTES:

- 1. REMOVE EXISTING ROOF AS REQUIRED TO INSTALL NEW DECKING
- 2. FASTEN ENDS OF METAL DECK A MINIMUM OF 6" O.C. INTO THE BAR JOISTS. FASTEN SIDE LAPS 24" O.C.
- 3. THE NEW DECKING SHALL BE NESTED INTO THE EXISTING DECKING
- 4. IF THE OPENING SPAN IS GREATER THAN BAR JOIST SPACING ON THE BUILDING, THE ARCHITECT SHALL BE CONTACTED FOR DIRECTION
- 5. IF THERE IS UPTURNED FRAMING AROUND THE OPENING, THE CONSULTANT SHALL BE CONTACTED FOR DIRECTION

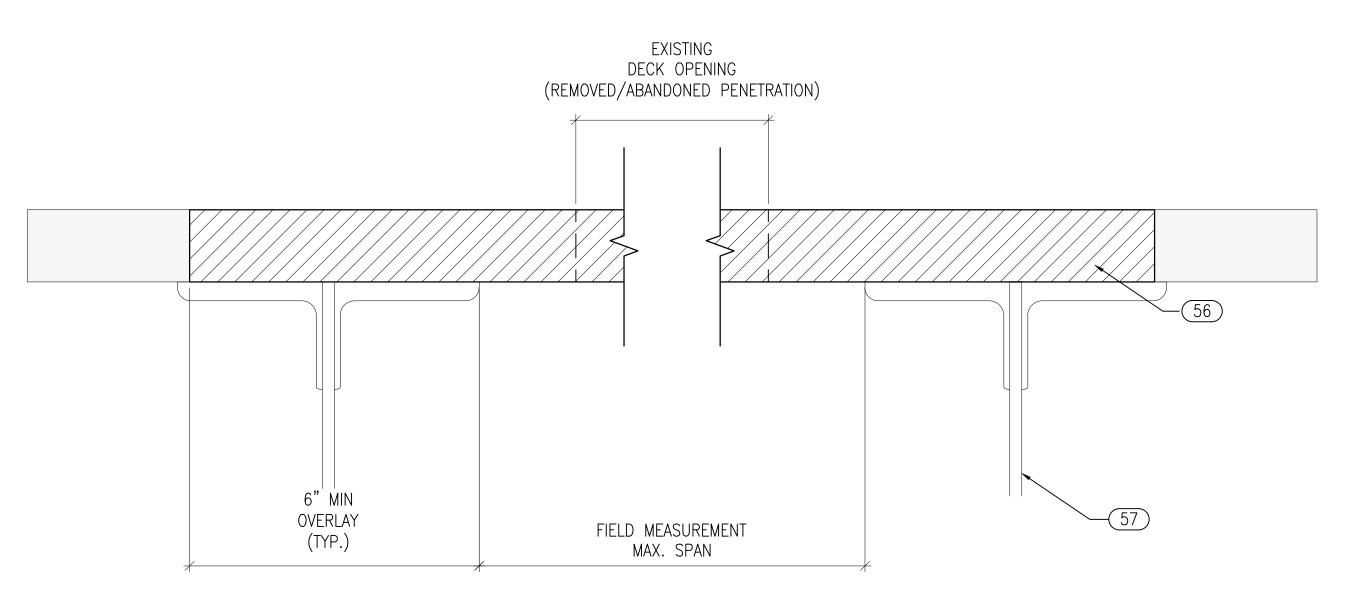

\A-141|A-503/

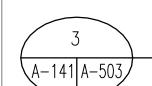

A-141 A-503

SCALE: 3'' = 1'-0''

METAL ROOF DECK INSTALLATION AT REMOVED PENETRATION

SCALE: 6" = 1'-0"

BID DOCUMENTS

CONSULTANTS

┌─ ROOF MEMBRANE

--- COVER BOARD


ROOF INSULATION


► METAL ROOF DECK

EXISTING CONSTRUCTION TO REMAIN; INSPECT AND MODIFY AS INDICATED AND SPECIFIED

1/2" SPRAY FOAM INSULATION

5521 Research Park Drive Suite 300 | Baltimore, Maryland 21228 p (410) 654-3790 www.primeeng.com

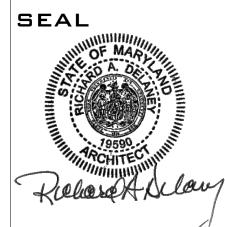

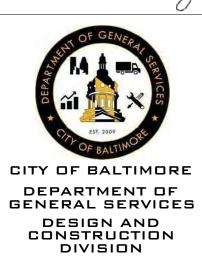

REVISIONS


COMTRAGE

SHEET NAME


TYPICAL DETAILS

8/03/2022

SHEET A-503

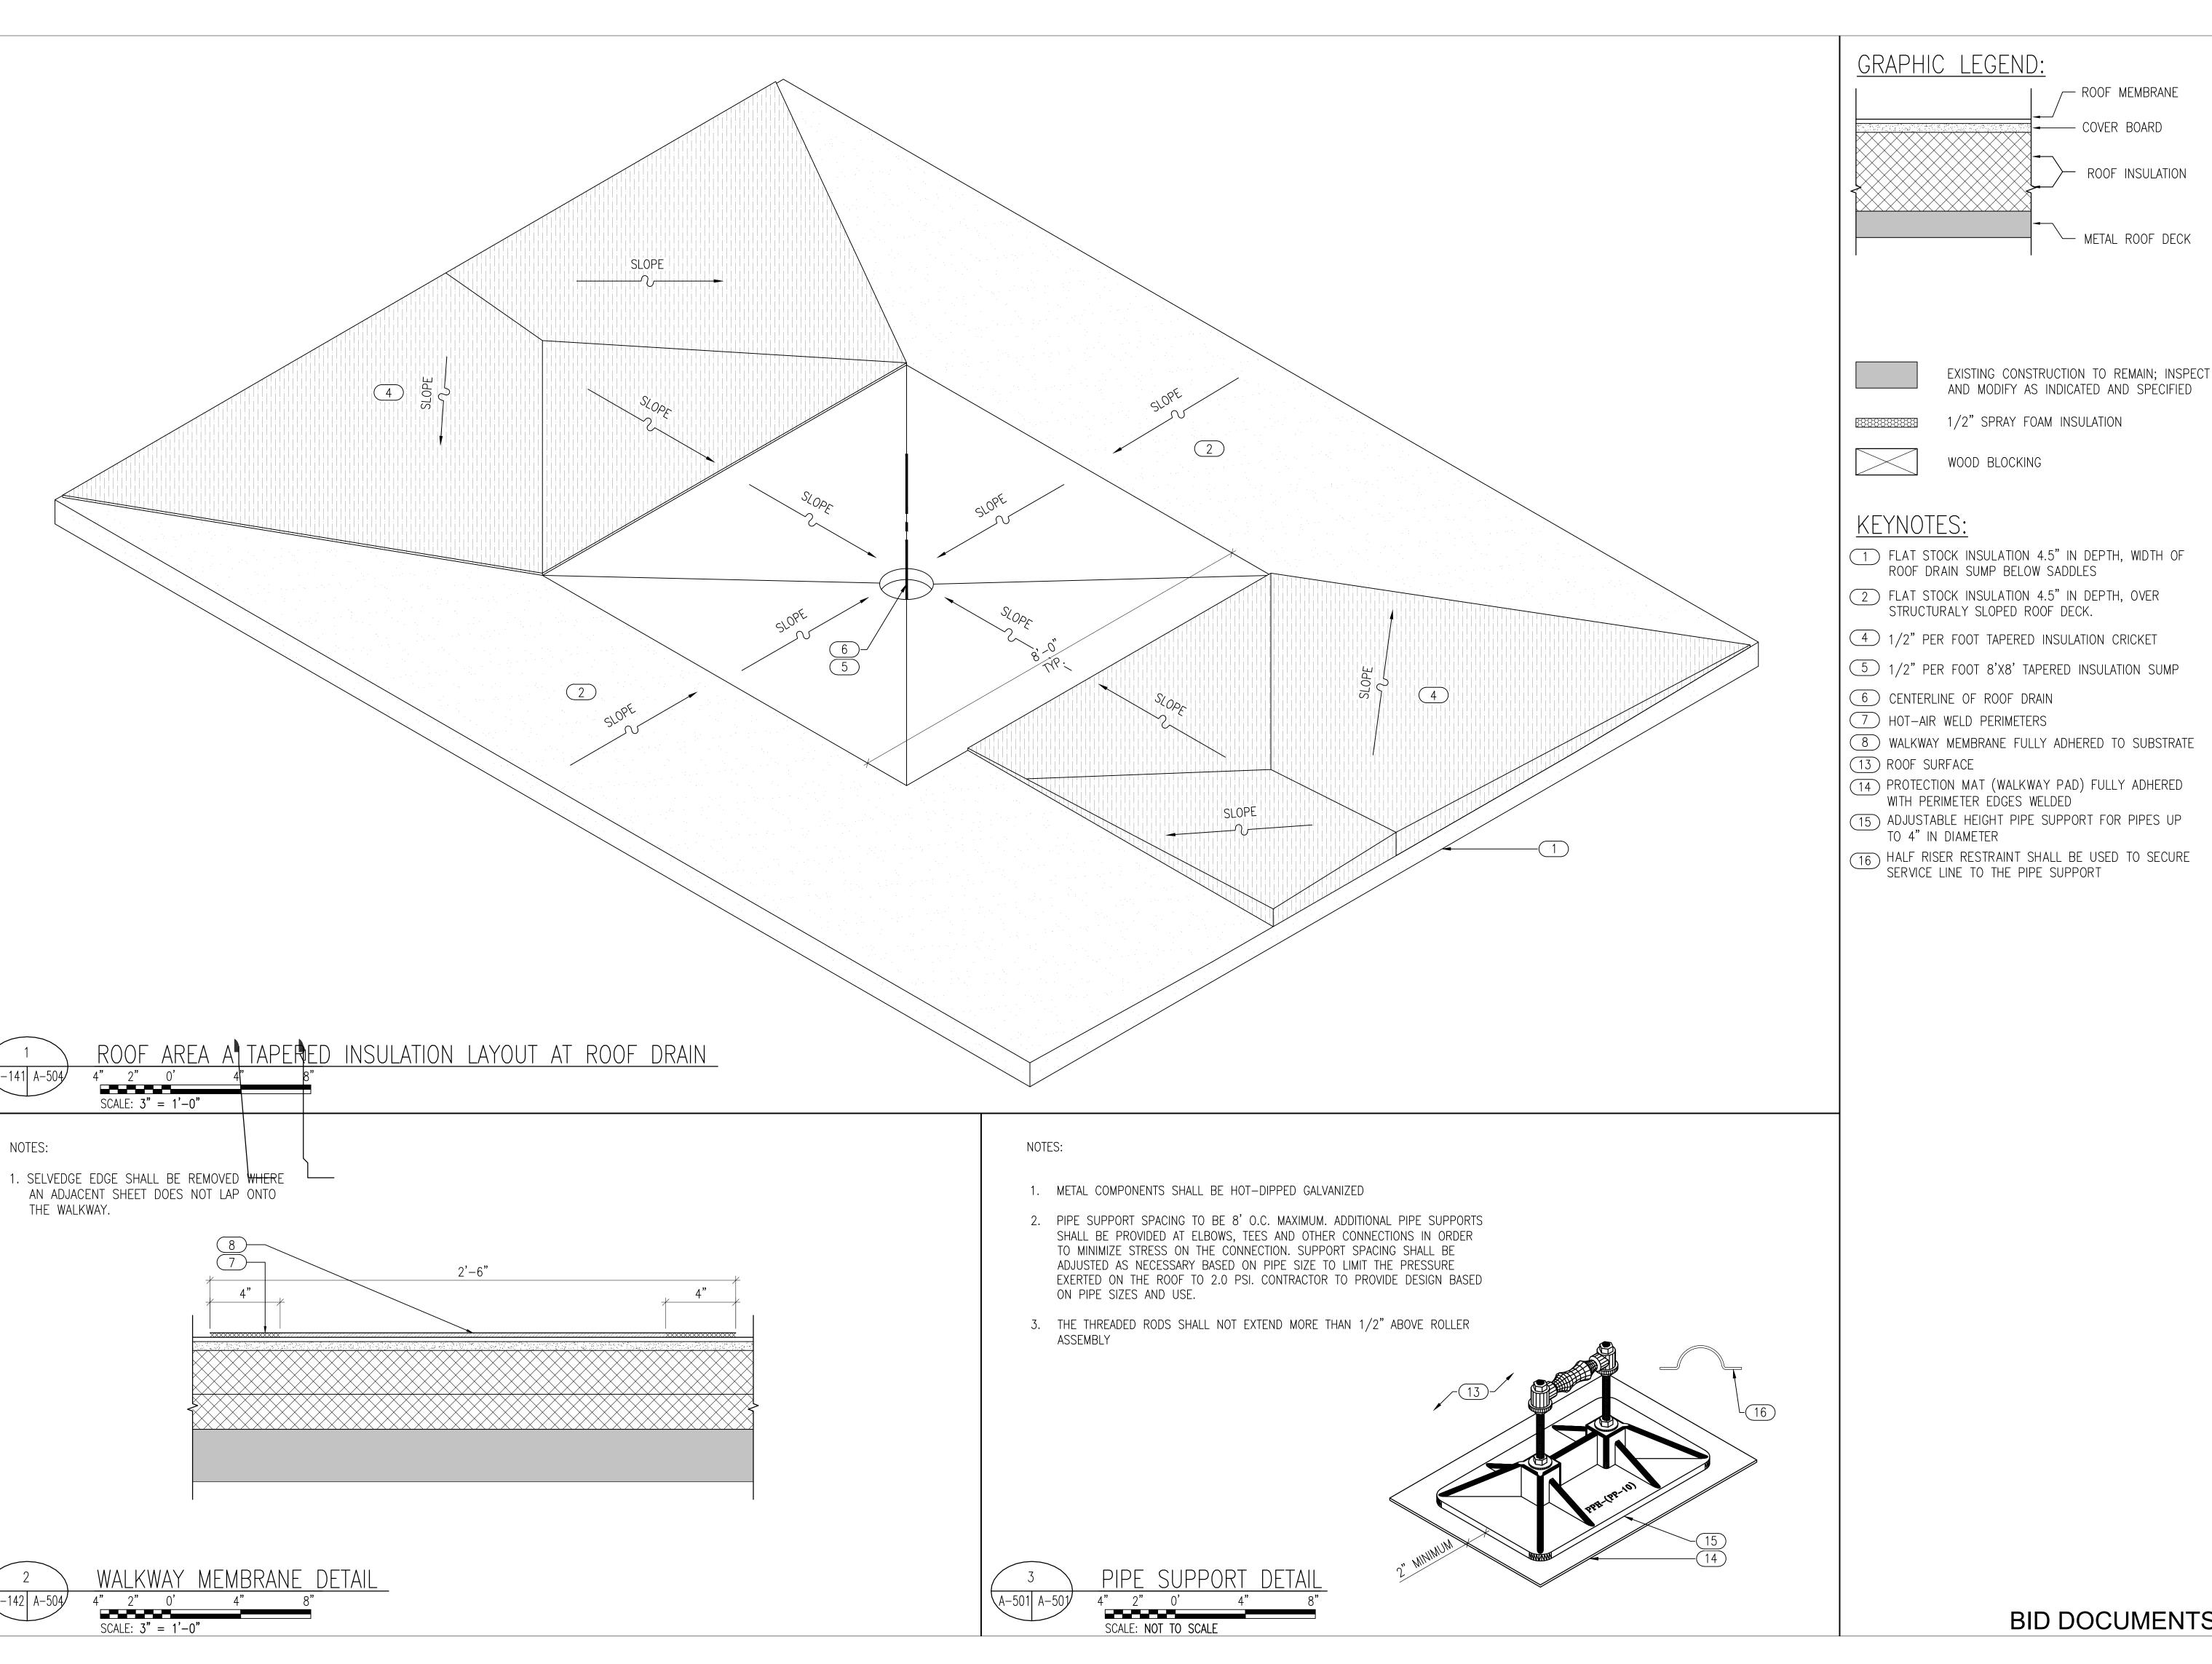

GRAPHIC LEGEND:

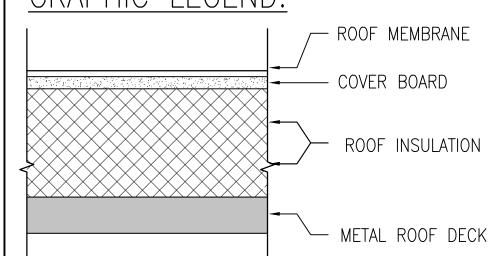

CONSULTANTS

Suite 300 | Baltimore, Maryland 21228 p (410) 654-3790 www.primeeng.com

SEAL



Killar Allaw

CITY OF BALTIMORE DEPARTMENT OF GENERAL SERVICES DESIGN AND CONSTRUCTION DIVISION

REVISIONS


SHEET NAME


TYPICAL DETAILS

8/03/2022

SHEET A-504


BID DOCUMENTS

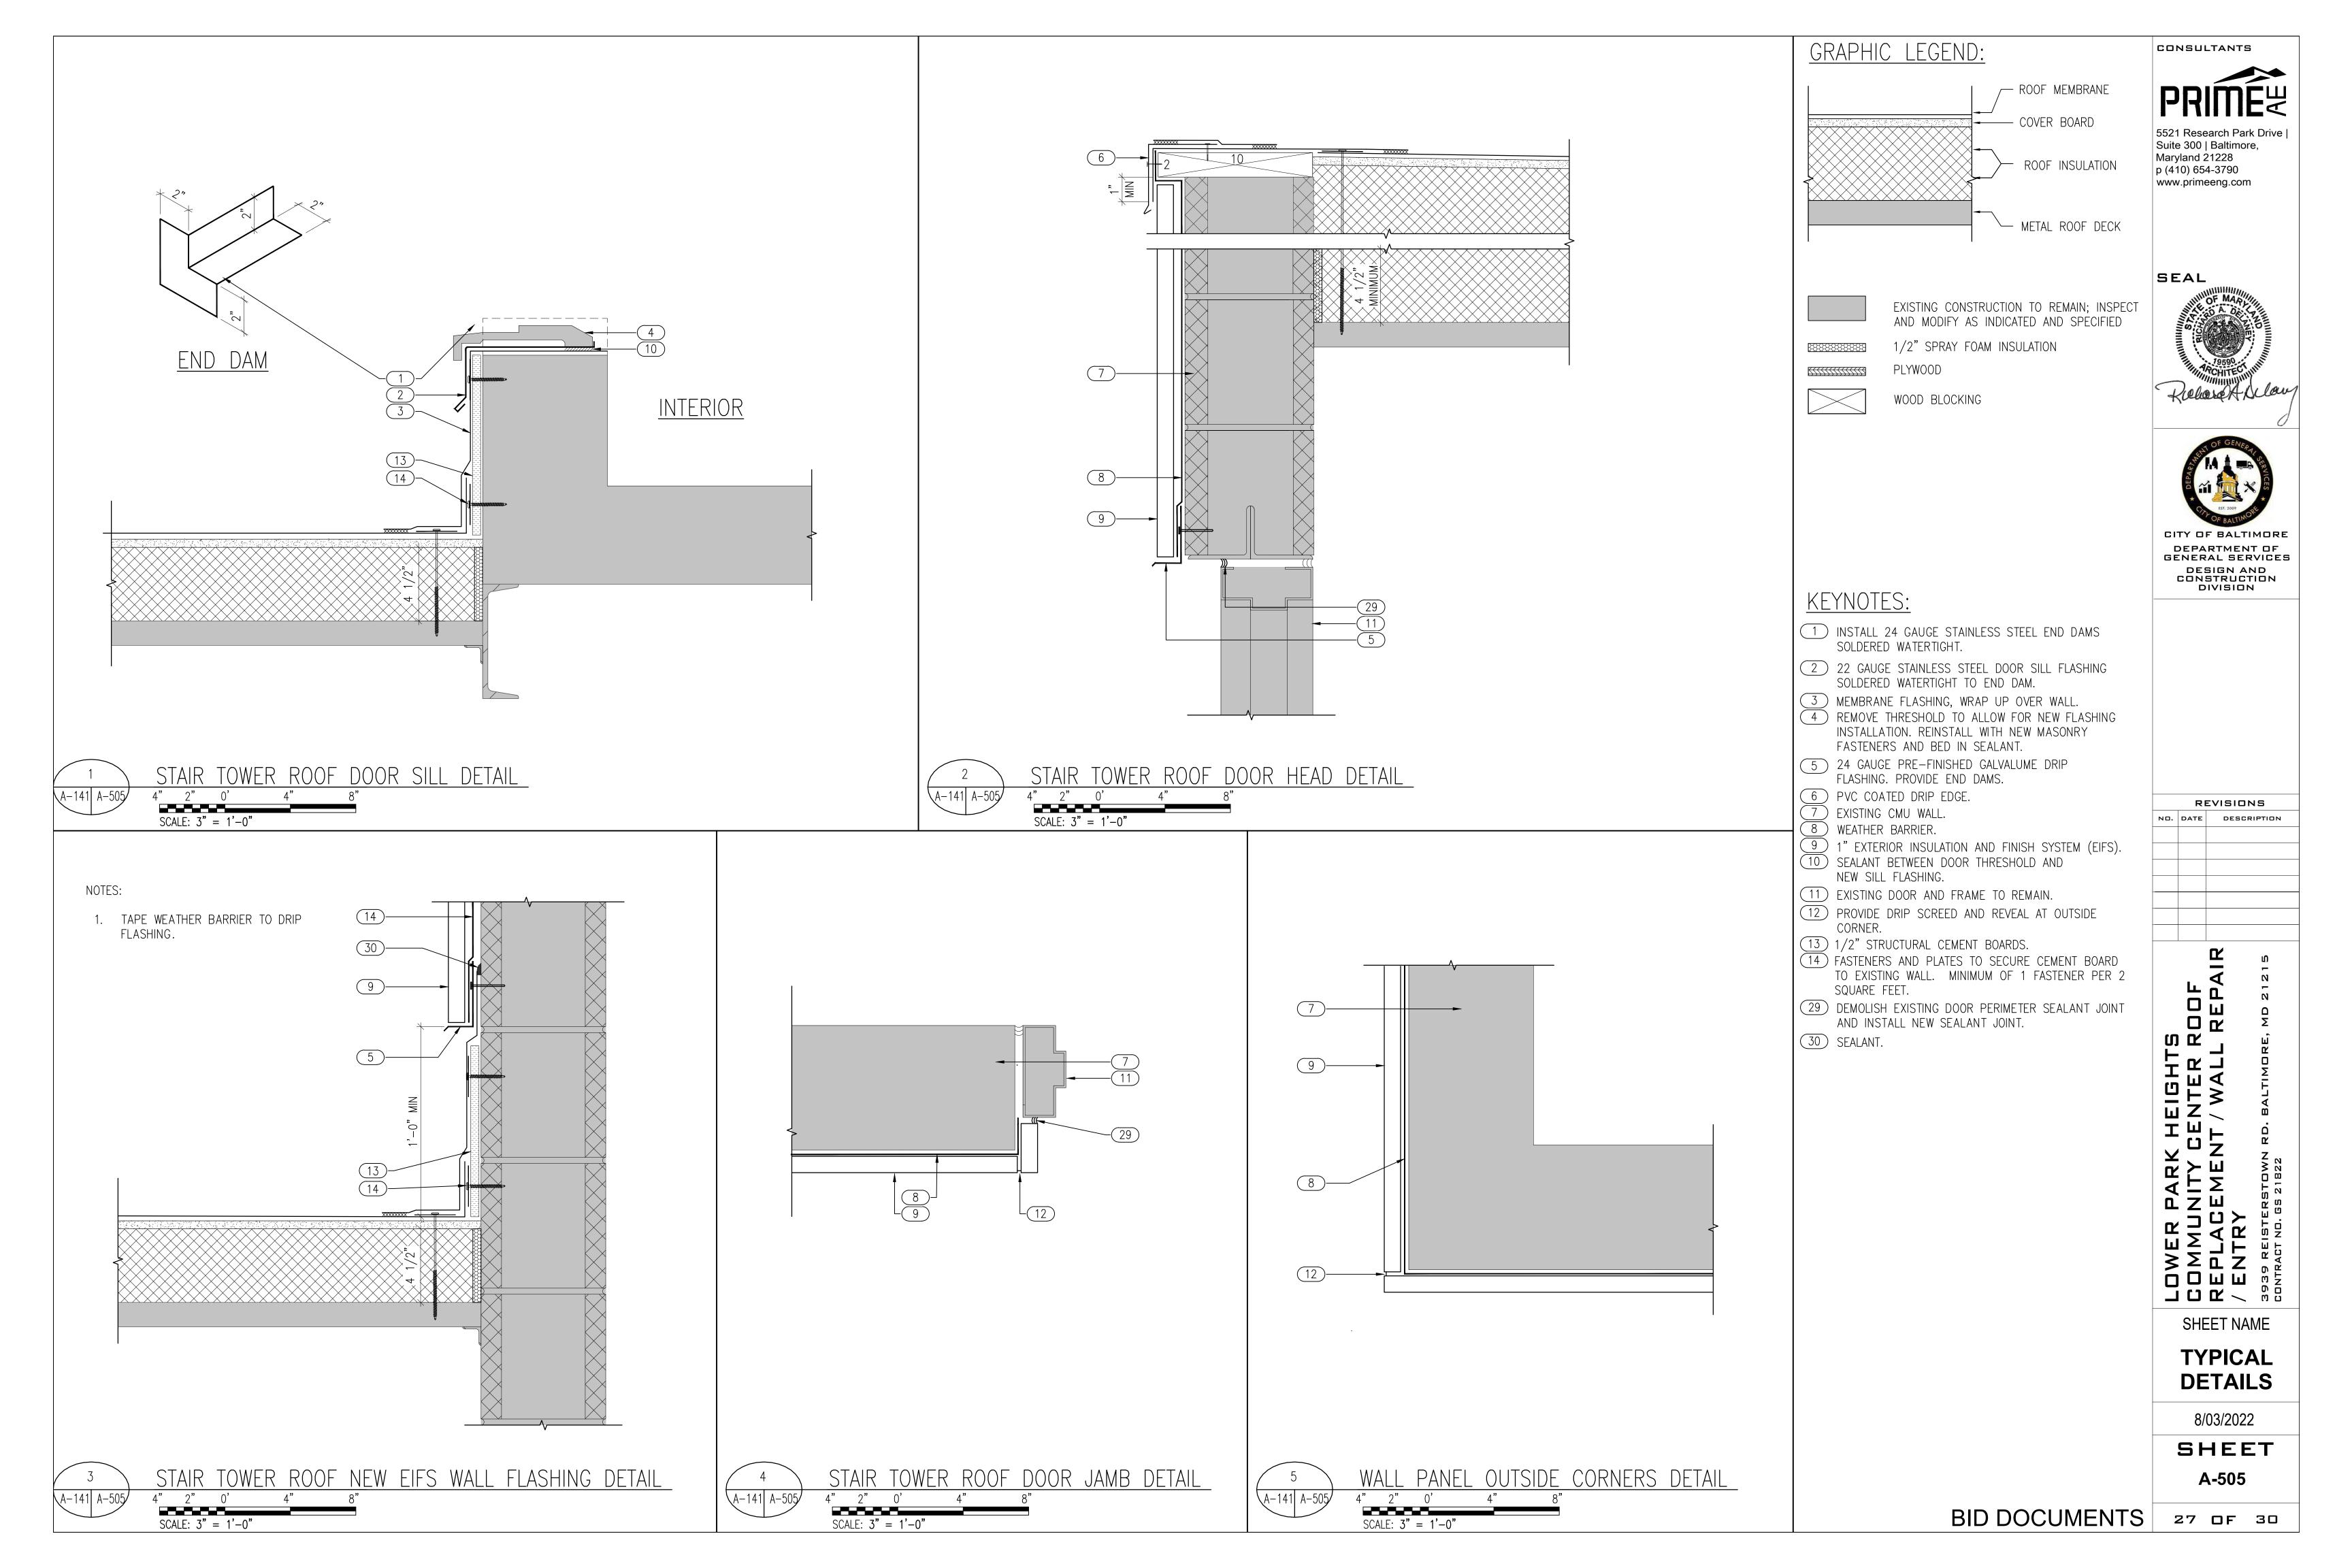


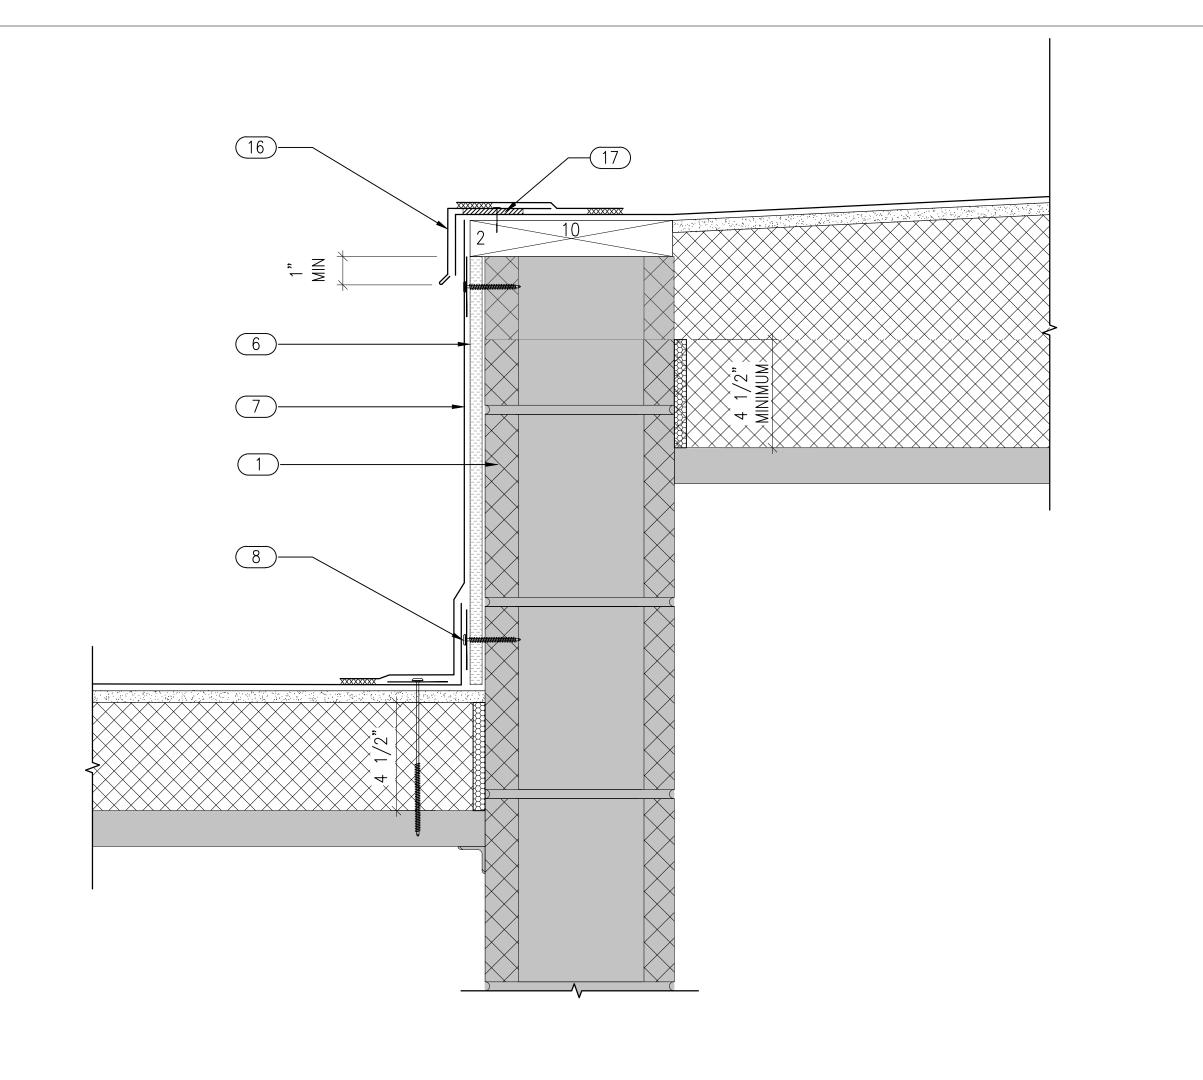


NOTES:

TAPE WEATHER BARRIER TO ALL PENETRATIONS.

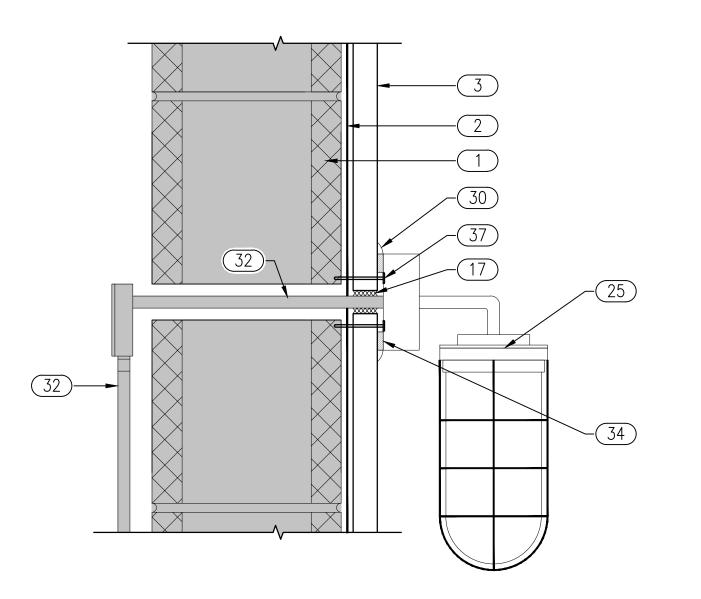

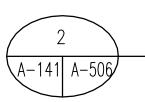


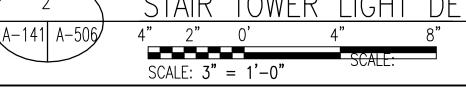


4" 2" 0' 4"

SCALE: NOT TO SCALE


\A-141 A-506

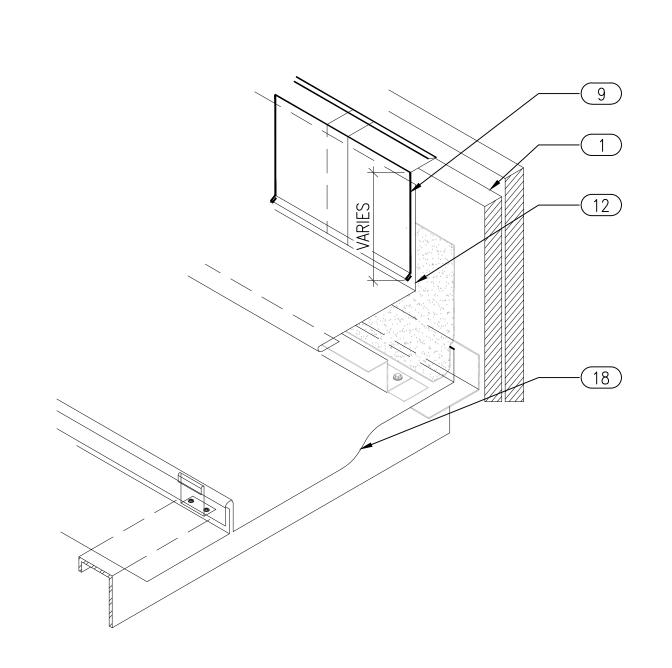

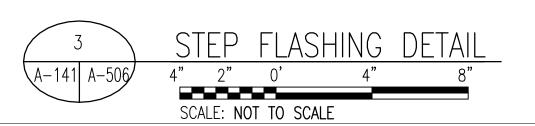


A-141 A-506

SCALE: 3'' = 1'-0''

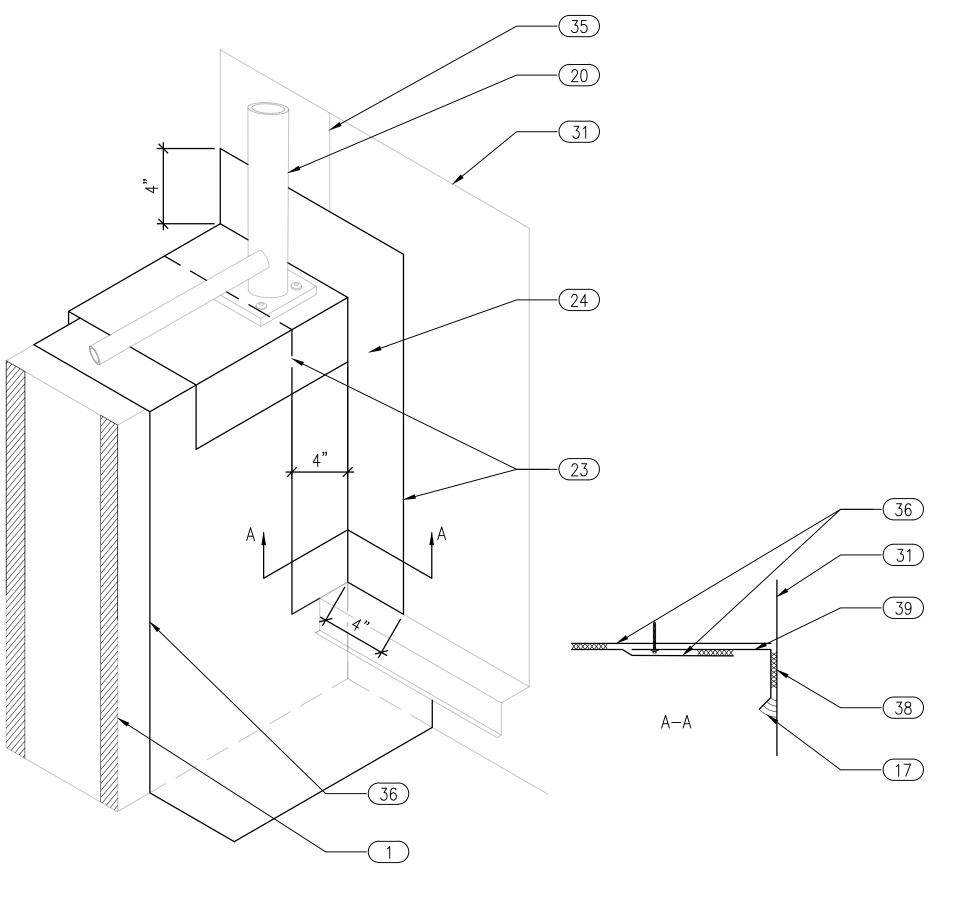


PARAPET TERMINATION AT TRANSLUCENT WALL PANEL DETAIL

GRAPHIC LEGEND:

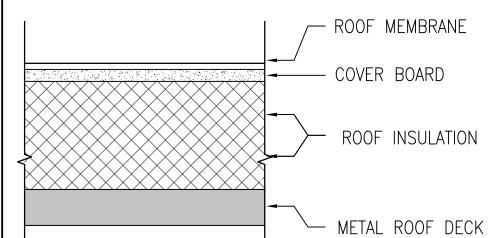




CONSULTANTS

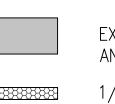



EXISTING CONSTRUCTION TO REMAIN; INSPECT AND MODIFY AS INDICATED AND SPECIFIED

1/2" SPRAY FOAM INSULATION PLYWOOD

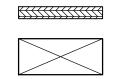

WOOD BLOCKING

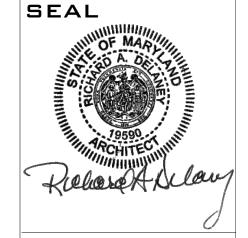

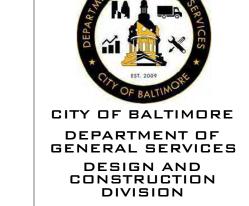

KEYNOTES:

- EXISTING CMU WALL.
- WEATHER BARRIER.
- $^{
 m)}$ 1" EXTERIOR INSULATION AND FINISH SYSTEM (EIFS). 5 NOT USED.
- (6) 1/2" STRUCTURAL CEMENT BOARD.
-) MEMBRANE FLASHING, EXTEND UP FACE OF WALL. (8) FASTENERS AND PLATES TO SECURE CEMENT BOARD TO EXISTING WALL. MINIMUM OF 1 FASTENER PER 2 SQUARE FEET.
- 9 .032" MILL FINISH ALUMINUM STEP FLASHING W/ 1" DEEP RECEIVER W/ $\frac{1}{4}$ " WEDGE SET IN SEALANT. MATCH EXISTING
- 12 EXISTING ROOF TO WALL FLASHING, TO REMAIN.
- 16 PVC COATED ROOF EDGE FLASHING SET IN BED OF SEALANT. FASTENED 3" O.C. STAGGERED
- 17 SEALANT.
- (18) EXISTING STANDING SEAM ROOF PANEL
- 20 EXISTING PLATE/CHAIN LINK FENCE
- 23 PVC COATED 24 GA GALVANIZED STEEL. TURN UP PARAPET WALL AND UNDER COPING. TAPE SEAL TO WALL PANEL
- 24 HEAT WELD PVC TO METAL
- (25) DEMOLISH EXISTING LIGHT FIXTURE AND REPLACE WITH NEW FIXTURE (TO BE CHOSEN BY OWNER) AND WATERPROOF WALL-MOUNTED JUNCTION BOX.
- (30) SEALANT BETWEEN JUNCTION BOX AND EIFS. LEAVE 1/2" GAP AT BOTTOM TO ALLOW INCIDENTAL WATER DRAINAGE
- 31 EXISTING TRANSLUCENT WALL PANEL
- 32) SERVICE FEED FOR LIGHT
- 34 INSTALL NEW GASKETS BETWEEN JUNCTION BOX AND
- 35 EXISTING VERTICAL BATTEN
- 36) PVC MEMBRANE
- 37) TAP CON TO EXISTING MASONRY
- 38) BUTYL SEALANT
- 39 PVC COATED METAL FASTENED 8" O.C., BED IN SEALANT

REVISIONS			
NO.	DATE	DES	CRIPTION
		A R	N 1 5

REP/ CONTRAC

SHEET NAME

TYPICAL DETAILS


8/03/2022

SHEET

A-506

28 **OF** 30

BID DOCUMENTS

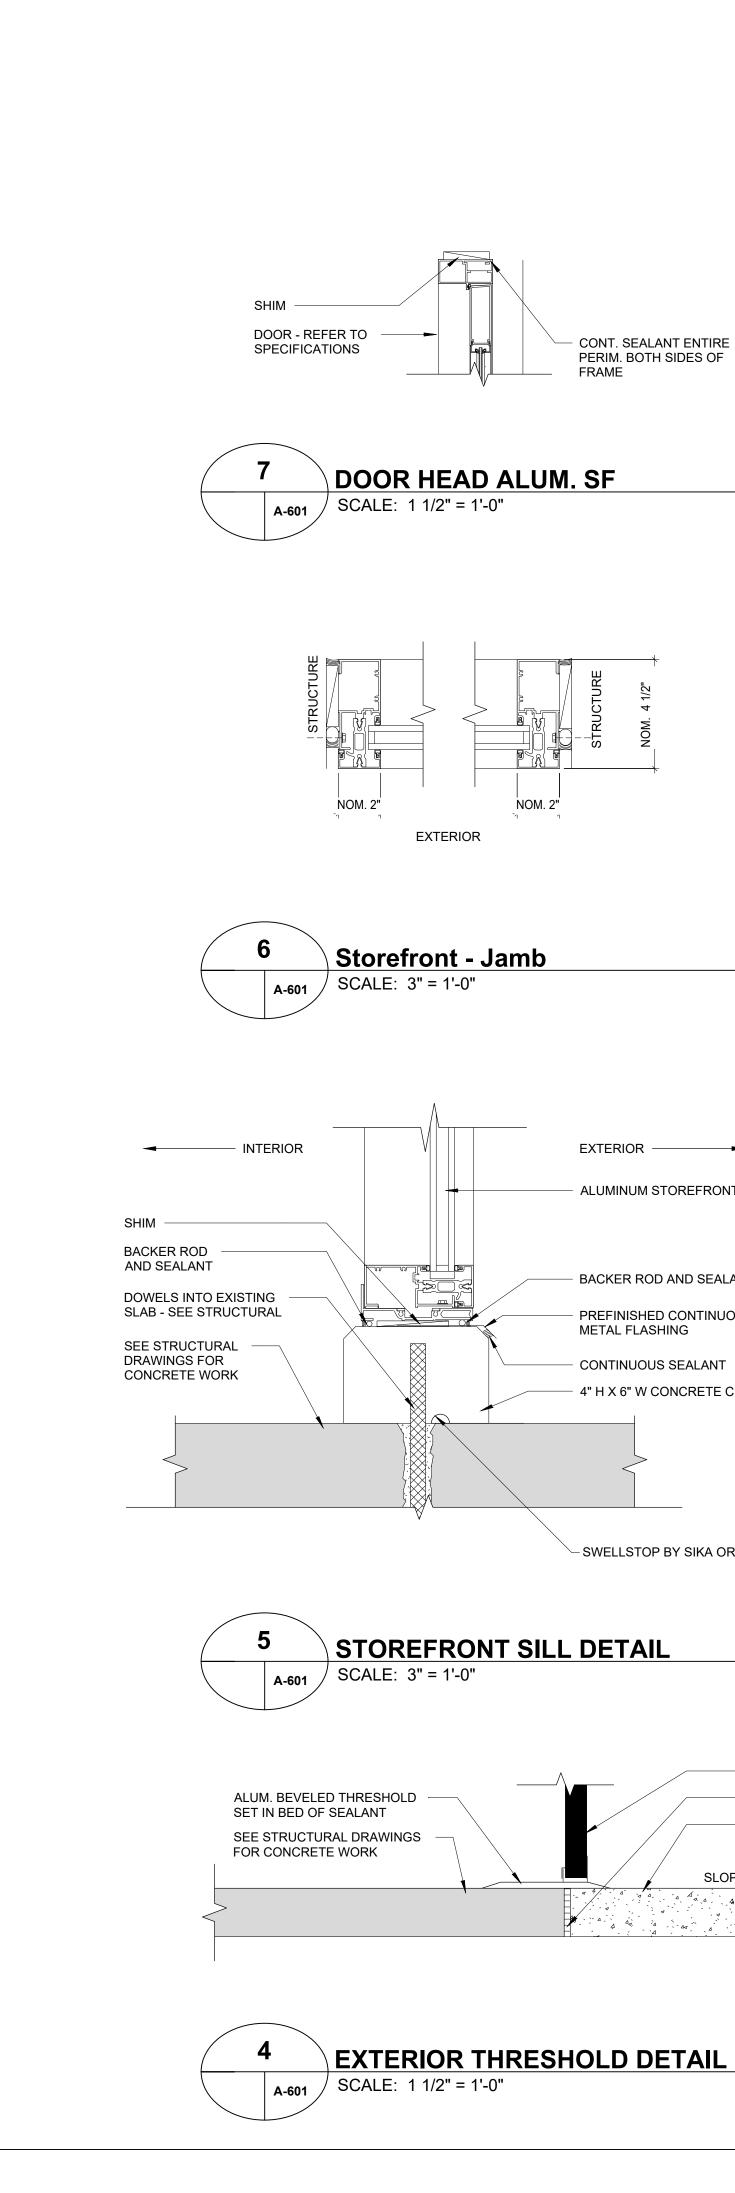

CONT. SEALANT ENTIRE

EXTERIOR ---

BACKER ROD AND SEALANT

PREFINISHED CONTINUOUS

- 4" H X 6" W CONCRETE CURB

SWELLSTOP BY SIKA OR EQUAL

METAL FLASHING

- CONTINUOUS SEALANT

6/A-601—

DOOR - REFER TO SCHEDULE

SEE STRUCTURAL DRAWINGS

1/2" EXPANSION JOINT

FOR CONCRETE WORK

SLOPE -

ALUMINUM STOREFRONT SYSTEM

PERIM. BOTH SIDES OF


GENERAL NOTES

- 1. NEW STOREFRONT SYSTEM FINISH TO MATCH EXISTING.
- 2. ALL DOOR HARDWARE (REFER TO SPECIFICATIONS) TO COMPLY WITH ADA ACCESSIBILITY REQUIREMENTS AND CITY OF BALTIMORE REQUIREMENTS.
- 3. GLAZING AT NEW STOREFRONT ENTRANCE TO BE TEMPERED INSULATED.
- 4. VESTIBULE LID SYSTEM MEMBERS TO BE SIZED BY STOREFRONT SYSTEM
- MANUFACTURER TO MEET SPAN AND LOADING REQUIREMENTS.
- 5. GLAZING AT VESTIBULE LID TO BE TEMPERED INSULATED.



5521 Research Park Drive | Suite 300 | Baltimore, Maryland 21228 p (410) 654-3790 www.primeeng.com

SEAL

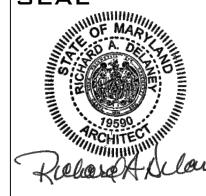



CITY OF BALTIMORE DEPARTMENT OF **GENERAL SERVICES** DESIGN AND CONSTRUCTION DIVISION

REVISIONS DATE DESCRIPTION

COOF REP/ ល ៤

COMMUN REPLACE / ENTRY SHEET NAME


DOOR DETAILS

8/03/2022


SHEET A-601

BID DOCUMENTS


29 OF 30

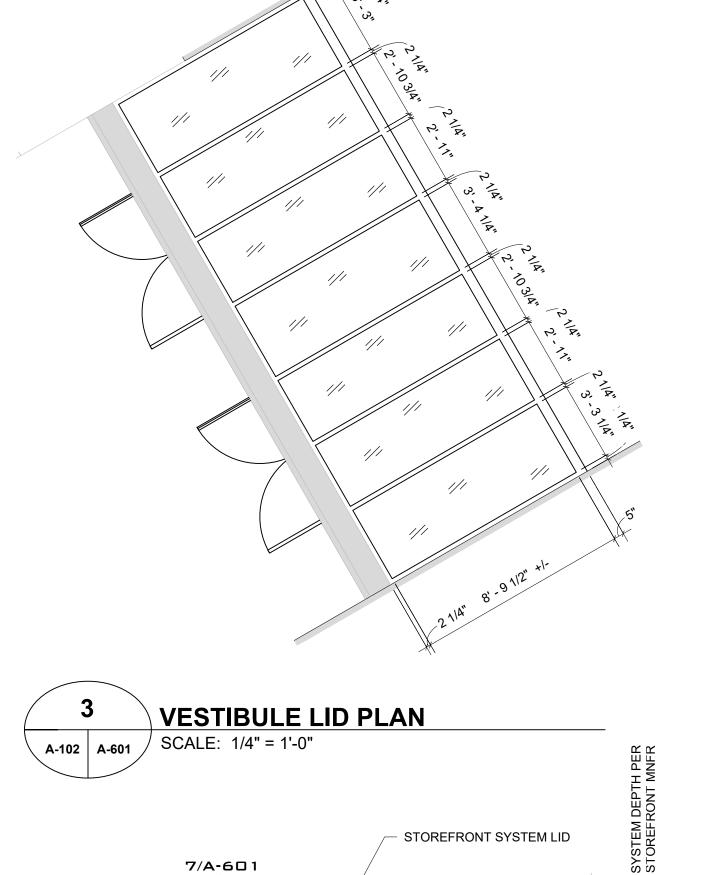

1//

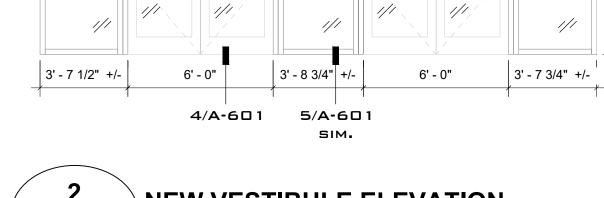

NEW VESTIBULE ELEVATION SCALE: 1/4" = 1'-0" A-101 A-601 /

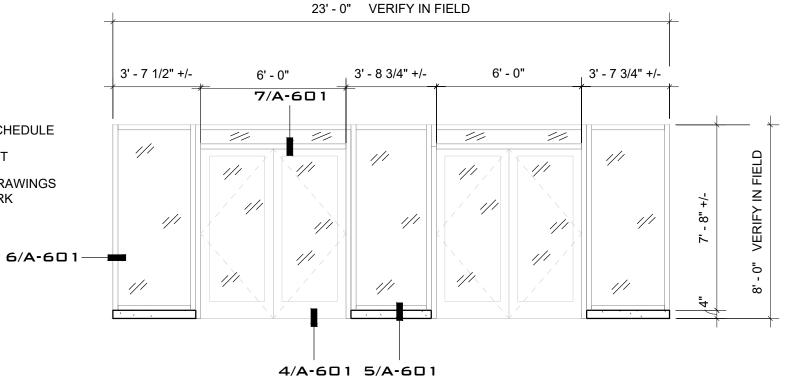

NEW STOREFRONT ELEVATION A-101 A-601

SCALE: 1/4" = 1'-0" GRAPHIC SCALE

FOUNDATION AND SLAB ON GRADE:

ALL FILL UNDER SLABS-ON-GRADE SHALL BE COARSE GRANULAR MATERIAL COMPACTED TO 95% OF MAXIMUM DENSITY AT OPTIMUM WATER CONTENT. SLABS-ON-GRADE SHALL BE POURED IN ACCORDANCE WITH ACI 302.1R, "GUIDE FOR CONCRETE FLOOR AND SLAB CONSTRUCTION" (LATEST LOCAL APPROVED EDITION). SAW CUT CONTROL JOINTS SUCH THAT TOTAL AREA BOUNDED BY SAW CUTS AND FORMED EDGES DOES NOT EXCEED 400 SQ./FT. AND LONG SIDE TO SHORT SIDE DOES NOT EXCEED A 1.5:1 RATIO. PROVIDE #4 x3'-0" LONG BAR AT MID-DEPTH OF SLAB AT ALL RE-ENTRANT CORNERS AND COLUMN ISOLATION JOINT CORNERS THAT DO NOT HAVE A CONTROL/CONSTRUCTION JOINT TERMINATING.

CONCRETE:

ALL CONCRETE, EXCEPT AS NOTED, SHALL BE fc=3000 PSI NORMAL WEIGHT CONCRETE AT 28 DAYS. ALL CONCRETE EXPOSED TO THE WEATHER SHALL BE fc=5000 PSI NORMAL WEIGHT CONCRETE AND SHALL BE AIR ENTRAINED FOR EXPOSURE CLASS F2 PER ACI 318. "BUILDING CODE REQUIREMENTS FOR STRUCTURAL CONCRETE" (LATEST LOCAL APPROVED EDITION).

ALL REINFORCING STEEL SHALL BE DEFORMED BILLET STEEL CONFORMING TO ASTM DESIGNATION A615 (LATEST LOCAL APPROVED EDITION), GRADE 60. ALL REINFORCING STEEL SHALL BE DETAILED, FABRICATED AND PLACED IN ACCORDANCE WITH ACI SP-66, "ACI DETAILING MANUAL" (LATEST LOCAL APPROVED EDITION).

ALL SPLICES IN REINFORCING SHALL BE CLASS "B" SPLICES IN ACCORDANCE WITH ACI 318, "BUILDING CODE REQUIREMENTS FOR STRUCTURAL CONCRETE" (LATEST LOCAL APPROVED EDITION) EXCEPT AS OTHERWISE NOTED.

WELDED WIRE FABRIC (W.W.F.) SHALL HAVE ENDS LAPPED ONE FULL MESH AND BE ADEQUATELY SUPPORTED BY CHAIRS OR BOLSTERS. WELDED WIRE FABRIC SHALL BE PLACED WITHIN THE UPPER THIRD OF THE SLABS ON GRADE AND 3/4" CLEAR FROM THE TOPS OF THE SLABS ON METAL DECK.

UNLESS OTHERWISE NOTED ON STRUCTURAL DRAWINGS, PROVIDE CONCRETE PROTECTION FOR REINFORCING AS FOLLOWS: CAST AGAINST EARTH ---- 3"

EXPOSED TO EARTH OR WEATHER: NO. 6 AND LARGER BARS ----- 2"

NO. 5 AND SMALLER BARS ---- 1 1/2" NOT EXPOSED TO EARTH OR WEATHER:

SLABS AND WALLS ---- 3/4" BEAMS AND COLUMNS ----- 1 1/2" TO TIES, STIRRUPS OR SPIRALS

THE CONTRACTOR MUST SUBMIT A CONCRETE DESIGN MIX IN ACCORDANCE WITH ACI 318 (LATEST LOCAL APPROVED EDITION). SUCH DESIGN MIX SHALL BE ACCOMPANIED BY THE APPROPRIATE GRAPHS AND BACKGROUND DATA. CONCRETE DESIGN MIX SHALL INDICATE 7 AND 28 DAY STRENGTHS, CEMENT CONTENT, WATER-CEMENT RATIO, FINE AND COARSE AGGREGATES AND ADMIXTURES FOR EACH DESIGN STRENGTH. THE ADDITION OF WATER AT THE PLANT OR IN THE FIELD GREATER THAN THE SPECIFIED WATER CONTENT IS STRICTLY PROHIBITED.

NOTE: 7

ALL CONCRETE WORK SHALL CONFORM TO THE LATEST LOCAL APPROVED EDITIONS OF THE FOLLOWING ACI AND ASTM DOCUMENTS: • ACI-301 SPECIFICATIONS FOR STRUCTURAL CONCRETE

•ACI-318 ---- CODE ●ACI-214 ----- COMPRESSIVE TEST

•ACI-306 ---- COLD WEATHER

•ACI SP-66 ----- DETAILING

•ACI-347 ----- FORMWORK

•ACI-305 ----- HOT WEATHER

• ACI-211---- PROPORTIONS OF CONCRETE • ACI-304 ----- PLACING CONCRETE

•ATSM C-94 ----- READY-MIX CONCRETE

ALL FIELD AND LAB TESTING OF CONCRETE SHALL CONFORM TO THE LATEST LOCAL APPROVED EDITIONS OF ASTM:

•ASTM C-31 FIELD CYLINDER SPECIMENS

◆ASTM C-143 SLUMP TEST

•ASTM C-231 AIR CONTENT (WHEN REQUIRED) • ASTM C-39 LAB TESTING CYLINDERS

•ASTM C-172 SAMPLING FRESH CONCRETE

• ASTM C-42 HARDENED CORES (WHEN REQUIRED) TEST RESULTS SHALL BE SIGNED AND SEALED BY A PROFESSIONAL

ENGINEER REGISTERED IN THE LOCAL JURISDICTION.

MASONRY

CONCRETE MASONRY SHALL CONFORM TO THE LATEST EDITION OF ASTM SPECIFICATION C90. CONCRETE MASONRY SHALL BE SAMPLED AND TESTED BY THE MASONRY SUPPLIER ACCORDING TO ASTM C140. ALL CONCRETE MASONRY CONSTRUCTION SHALL CONFORM TO TMS 402/ACI 530/ASCE 5, "BUILDING CODE REQUIREMENTS FOR MASONRY STRUCTURES" (LATEST LOCAL APPROVED EDITION) AND TMS 602/ACI 530.1/ASCE 6, "SPECIFICATION FOR MASONRY STRUCTURES" (LATEST LOCAL APPROVED EDITION).

UNLESS OTHERWISE NOTED, CONCRETE MASONRY UNITS SHALL HAVE A MINIMUM COMPRESSIVE STRENGTH OF 2000 PSI ON THE NET AREA. ALL BRICK SHALL HAVE A MINIMUM COMPRESSIVE STRENGTH OF 3350 PSI ON THE NET AREA.

ALL MORTAR SHALL CONFORM TO ASTM C270. MORTAR TO BE USED SHALL BE SAMPLED AND TESTED BY THE BRICK AND MASONRY SUPPLIERS ACCORDING TO ASTM C780 AND RESULTS SUBMITTED TO THE ENGINEER FOR APPROVAL. MORTAR SHALL BE PORTLAND CEMENT/LIME MORTAR TYPE "S" AS A MINIMUM.

NOTE: 4

MASONRY CONSTRUCTION SHALL BE INSPECTED PER TMS 402/ACI 530/ASCE5 . "BUILDING CODE REQUIREMENTS FOR MASONRY STRUCTURES" (LATEST LOCAL APPROVED EDITION) FOR LEVEL B QUALITY ASSURANCE.

MASONRY CONTINUED:

TYPICAL INFILLING, REMOVAL AND REPAIR OF EXISTING MASONRY

WHERE NEW MASONRY IS TO BE ADDED, THE MASONRY SHALL BE TOOTHED AND MORTARED (SEE GUIDELINES FOR "REPAIR"). THE NEW MASONRY SHALL BEAR ON NEW CONCRETE FOUNDATIONS OR ON THE EXISTING MASONRY. IN THE LATER CASE, THE EXISTING MASONRY SHALL BE REMOVED TO GOOD, SOLID MATERIAL. THE DRAWINGS INDICATE THE APPROXIMATE EXTENT OF THE REQUIRED MASONRY INFILL. THIS IS A GUIDE ONLY AND THE EXACT EXTENT SHALL BE DETERMINED BY THE CONTRACTOR BASED ON FIELD CONDITIONS. WHEN THE RESULTING MASONRY WOULD BE PART NEW AND PART EXISTING AND WOULD FORM A PIER OR OTHERWISE SMALL ELEMENT. REMOVE ALL THE EXISTING MASONRY AND MAKE A NEW PIER OR WALL.

IN THOSE AREAS WHERE NEW OPENINGS MUST BE MADE THROUGH EXISTING MASONRY WALLS, THE EXISTING MASONRY SHALL BE CAREFULLY REMOVED AFTER THE WALL THAT REMAINS ABOVE THE PROPOSED OPENING HAS BEEN TEMPORARILY SUPPORTED OR AFTER THE LINTELS HAVE BEEN PUT IN PLACE. ANY REQUIRED CUTTING BEYOND THE MASONRY OPENING SHALL BE PATCHED WITH MASONRY AND MORTAR (SEE GUIDELINES FOR "REPAIR"). WHEN THE MASONRY THAT REMAINS AFTER REMOVAL WOULD RESULT IN A PIER OR OTHERWISE SMALL ELEMENT, THE EXISTING MASONRY SHALL BE REMOVED AND A NEW PIER OR WALL SHALL BE CONSTRUCTED THE CONTRACTOR SHALL PROVIDE DRAWINGS SIGNED AND SEALED BY A PROFESSIONAL ENGINEER REGISTERED IN THE LOCAL JURISDICTION SHOWING THE SUPPORT OF THE WALLS PRIOR TO AND DURING THE INSTALLATION OF LINTELS REQUIRED TO SUPPORT THE MASONRY ABOVE THE NEW OPENING.

IN THOSE AREAS WHERE THE EXISTING MASONRY HAS DETERIORATED, SAGGED OR CRACKED, THE MASONRY SHALL BE REMOVED AND REPLACED. EXISTING BRICKS MAY BE RE-USED PROVIDED THAT THEY ARE IN GOOD CONDITION. THE NEW MORTAR USED TO REPLACE THE EXISTING MORTAR SHALL MATCH SOUND EXISTING MORTAR IN STIFFNESS AND CONSISTENCY. IF NEW BRICKS ARE REQUIRED, THEY ALSO SHALL MATCH EXISTING BRICKS IN GOOD CONDITION. THE NEW MASONRY SHALL BE TOOTHED INTO THE EXISTING WALL. THE ARCHITECT SHALL APPROVE ALL NEW MASONRY WORK.

POST-INSTALLED ANCHORS AND REINFORCING:

ALL ANCHORS SHALL BE THE FOLLOWING TYPES MANUFACTURED BY HILTI

a.ADHESIVE ANCHORS IN CONCRETE: HILTI HIT-HY200 ANCHORING SYSTEM PER ICC ESR-3187 WITH HILTI HIT-Z THREADED ROD.

b. ADHESIVE ANCHORS IN SOLID GROUTED MASONRY: HILTI HIT-HY270 MASONRY ADHESIVE SYSTEM PER ICC ESR-4143/ESR-4144 WITH HILTI HAS-E CONTINUOUSLY THREADED ROD.

c. ADHESIVE ANCHORS IN HOLLOW AND MULTI-WYTHE MASONRY: HILTI HIT-HY270 MASONRY ADHESIVE SYSTEM PER ICC ESR-4143/ESR-4144 WITH HILTI HAS-E CONTINUOUSLY THREADED ROD AND APPROPRIATE SIZE SCREEN TUBE.

d.MECHANICAL ANCHORS IN CONCRETE: HILTI KWIK BOLT TZ2 EXPANSION **ANCHOR PER ICC ESR-4266**

e.MECHANICAL ANCHORS IN SOLID GROUTED MASONRY: HILTI KWIK BOLT TZ2 EXPANSION ANCHOR PER ICC ESR-4561

ALTERNATE MANUFACTURERS OR ANCHORS MUST BE SUBMITTED TO THE ARCHITECT FOR REVIEW AND APPROVAL PRIOR TO USE. THE CONTRACTOR SHALL PROVIDE SIGNED AND SEALED CALCULATIONS DEMONSTRATING THAT THE PROPOSED SUBSTITUTIONS, BASED ON THEIR SPECIFIC ICC-ES EVALUATION REPORTS, ARE CAPABLE OF ACHIEVING THE PERFORMANCE VALUES EQUAL TO OR GREATER THAN THOSE OF THE ANCHORS SPECIFIED.

MECHANICAL ANCHORS AND REINFORCING SHALL NOT BE INSTALLED UNTIL THE CONCRETE OR GROUT HAS ATTAINED 70% OF ITS DESIGN STRENGTH.

ALL POST INSTALLED ANCHORS AND REINFORCING SHALL BE INSTALLED IN DRY HOLES THAT HAVE BEEN DRILLED, CLEANED AND PREPARED IN STRICT ACCORDANCE WITH THE MANUFACTURER'S WRITTEN INSTALLATION INSTRUCTIONS AND THE RESPECTIVE ICC ES EVALUATION REPORTS.

MECHANICAL ANCHORS INSTALLED IN GROUTED MASONRY SHALL BE

LOCATED A MINIMUM 1 ½" FROM VERTICAL MORTAR JOINTS.

NOTE: 5 POST INSTALLED ANCHORS AND REINFORCING SHALL ONLY BE USED WHERE SPECIFIED IN THE CONTRACT DRAWINGS. THE CONTRACTOR SHALL OBTAIN APPROVAL FROM COLUMBIA ENGINEERING INC. PRIOR TO INSTALLING POST INSTALLED ANCHORS WHERE CAST IN PLACE ANCHORS ARE MISSING, MISPLACED OR DAMAGED.

POST INSTALLED ANCHORS AND REINFORCING SHALL BE PERIODICALLY INSPECTED PER IBC 2018 SECTION 1705 EXCEPT ADHESIVE ANCHORS AND REINFORCING INSTALLED IN A VERTICAL OR OVERHEAD SURFACE SHALL BE CONTINUOUSLY INSPECTED.

EXISTING CONSTRUCTION:

COLUMBIA ENGINEERING INC. PREPARED THESE PLANS BASED ON A LIMITED AMOUNT OF FIELD EXPLORATION AND ON THE STRUCTURAL INFORMATION SHOWN IN DRAWINGS S1-S3 PREPARED BY SKARDA AND RICKERT DATED 4/20/1977. THE EXISTING MEMBER SIZES ARE NOTED (E) AND ARE SHOWN IN THE PLANS. THE CONTRACTOR SHALL VERIFY THAT THE EXISTING MEMBERS SHOWN IN THE PLANS MATCH EXISTING AS BUILT CONDITIONS PRIOR TO PREPARING SHOP DRAWINGS. IF THE AS BUILT CONDITIONS DO NOT CONFORM TO THE INFORMATION SHOWN IN THE PLANS, OR IF ANY STRUCTURAL MEMBER IS FOUND TO BE IN POOR CONDITION, THE CONTRACTOR SHALL INFORM COLUMBIA ENGINEERING INC. OF THE ACTUAL SIZES AND/OR CONDITION. RE-DESIGN AND ADDITIONAL FRAMING MAY BE REQUIRED IN THAT CASE.

NOTE: 2

ALL NEW PIPE AND DUCT PENETRATIONS SHALL BE LOCATED BY THE CONTRACTOR TO AVOID CONCRETE SLAB REINFORCEMENT AND SUPPORTING MEMBERS UNDER THE SLAB OR ROOF. IF CUTTING OF ANY REINFORCEMENT OR EXISTING SUPPORTING MEMBER CANNOT BE AVOIDED. THEN PRIOR TO CUTTING. THE CONTRACTOR SHALL PREPARE A DETAILED DRAWING SHOWING THE PROPOSED PENETRATION AND ALL THE AFFECTED REINFORCEMENT AND SUPPORTING MEMBERS AND SHALL SUBMIT THE DRAWING TO COLUMBIA ENGINEERING INC. FOR REVIEW AND APPROVAL. THE CONTRACTOR SHALL NOT CUT ANY REINFORCEMENT OR MEMBER WITHOUT THE PRIOR APPROVAL OF COLUMBIA ENGINEERING, INC.

MISCELLANEOUS:

ITEMS AND CONDITIONS NOTED OR IDENTIFIED IN SECTIONS AND DETAILS APPLY TO AREAS SIMILAR IN CONDITION TO THOSE DENOTED BY THE SECTION CUT OR DETAIL MARK.

NOTE: 2

THE CONTRACTOR SHALL NOTIFY THE ARCHITECT AND STRUCTURAL ENGINEER OF ANY DISCREPANCIES BETWEEN THE STRUCTURAL DOCUMENTS AND ANY OTHER DOCUMENTS OR EXISTING CONDITIONS FOR RESOLUTION PRIOR TO PROCEEDING WITH FABRICATION OR CONSTRUCTION.

NOTE: 3

SHOP DRAWINGS FOR ALL STRUCTURAL ITEMS MUST BE SUBMITTED BY THE CONTRACTOR. IF A CONTRACTOR OR OWNER FAILS TO SUBMIT THE SHOP DRAWINGS. THE FIRM COLUMBIA ENGINEERING, INC., WILL NOT BE RESPONSIBLE FOR THE STRUCTURAL CERTIFICATION AND/OR THE DESIGN OF THE PROJECT.

NOTE: 4 REPRODUCTION OF CONTRACT DOCUMENTS WILL NOT BE ACCEPTED AS SHOP DRAWINGS.

NOTE: 5

SHOP DRAWINGS FOR THE FOLLOWING ITEMS SHALL BE SUBMITTED FOR ARCHITECT/ENGINEER REVIEW:

a.CONCRETE/GROUT MIX DESIGNS

b.CONCRETE/MASONRY REINFORCING STEEL c.CONSTRUCTION/CONTROL JOINT LAYOUT FOR SLABS ON GRADE SEE SPECIFICATIONS FOR ADDITIONAL REQUIRED SUBMITTALS.

THE FOLLOWING ITEMS SHALL BE DESIGNED FOR LOADS INDICATED IN THE DRAWINGS AND IN THE LOCAL BUILDING CODE: a.CURTAINWALL SYSTEMS

b.HANDRAILS AND GUARDRAILS

c.LADDERS SHOP DRAWINGS AND CALCULATIONS SHALL BE SIGNED AND SEALED BY A PROFESSIONAL ENGINEER REGISTERED IN THE LOCAL JURISDICTION AND SUBMITTED FOR REVIEW.

ARCHITECT/ENGINEER, AND SHALL BE MARKED "REVIEWED" OR "REVIEWED AS NOTED."

NOTE: 7

NOTE: 8 THE CONTRACTOR SHALL SUPPORT ADJACENT STRUCTURES, UTILITIES, AND EXCAVATIONS. CONTRACTOR SHALL HAVE ALL TEMPORARY FORMWORK, SHEETING, SHORING, UNDERPINNING, ETC., AS PART OF THE CONTRACTOR'S WORK, SIGNED AND SEALED BY A PROFESSIONAL

ENGINEER REGISTERED IN THE LOCAL JURISDICTION.

ALL SHOP DRAWINGS USED FOR WORK SHALL BEAR THE STAMP OF THE

ALL WORK SPECIFIED HEREIN SHALL BE INSPECTED IN ACCORDANCE WITH IBC CHAPTER 17 (EXCEPTIONS NOTED SHALL NOT BE PERMITTED) AND ALL LOCAL ORDINANCES. INSPECTIONS REQUIRED SHALL BE PER THE STATEMENT OF SPECIAL INSPECTIONS NOTED ON THIS SHEET. THE OWNER SHALL HIRE AN EXPERIENCED, QUALIFIED INSPECTOR TO PERFORM ALL THE REQUIRED INSPECTION WORK. THE ENGINEER WILL NOT PERFORM THE REQUIRED INSPECTION AS A PART OF HIS DESIGN SERVICE. THE ENGINEER MAY VISIT THE SITE TO ASCERTAIN GENERAL CONFORMANCE TO THE CONTRACT DOCUMENTS, AND SUCH VISITS ARE NOT TO BE CONSTRUED AS MEETING INSPECTION REQUIREMENTS.

NOTE: 10

THE GENERAL CONTRACTOR AND ITS SUBCONTRACTORS SHALL HAVE A MINIMUM OF FIVE YEARS EXPERIENCE IN THE CONSTRUCTION OF WORK SIMILAR IN NATURE TO THIS PROJECT.

NOTE: 11

LEGAL USE OF DOCUMENTS

THE PLANS, SPECIFICATIONS AND OTHER INFORMATION CONTAINED IN THESE DRAWINGS (COLLECTIVELY THE "DRAWINGS") WERE PREPARED BY COLUMBIA ENGINEERING, INC. AND ARE INSTRUMENTS OF PROFESSIONAL SERVICES RENDERED AND DELIVERED PURSUANT TO THE TERMS AND CONDITIONS OF A WRITTEN AGREEMENT (THE "AGREEMENT") ONLY TO THE RECIPIENT NAMED THEREIN. ANY USE OF THE DRAWINGS BY ANY PARTY WHICH IS INCONSISTENT WITH THE TERMS AND CONDITIONS OF THE AGREEMENT IS EXPRESSLY PROHIBITED. COLUMBIA ENGINEERING, INC. EXPRESSLY RESERVES ITS COPYRIGHT AND ALL INTELLECTUAL PROPERTY AND OTHER RIGHTS IN THE DRAWINGS. NO PORTION OF THE DRAWINGS ARE TO BE REPRODUCED, CHANGED OR OTHERWISE USED IN ANY FORM OR MANNER WHATSOEVER WHICH IS INCONSISTENT WITH EITHER THE AGREEMENT OR THE PURPOSES FOR WHICH THEY WERE ORIGINALLY PREPARED. NOR ARE THEY TO BE DEEMED ASSIGNED TO ANY PERSON OR ENTITY WITHOUT OBTAINING THE EXPRESS PRIOR WRITTEN PERMISSION AND CONSENT OF COLUMBIA ENGINEERING, INC. THE RECIPIENT OF THE DRAWINGS AGREES TO INDEMNIFY AND HOLD HARMLESS COLUMBIA ENGINEERING, INC., ITS EMPLOYEES, OFFICERS, DIRECTORS AND AGENTS FROM AND AGAINST ANY AND ALL DAMAGES WHICH ARISE OUT OF OR IN CONNECTION WITH ANY VIOLATION OF THE FOREGOING.

DESIGN CODES:

INTERNATIONAL BUILDING CODE:

BUILDING CODE REQUIREMENTS FOR STRUCTURAL CONCRETE: ACI 318-14

BUILDING CODE REQUIREMENTS FOR MASONRY STRUCTURES: TMS 402/602-16

SPECIFICATION FOR STRUCTURAL STEEL BUILDINGS:

AISC 360-16 **DESIGN LOADS:**

IBC RISK CATEGORY 3

FLOOR LIVE LOADS: 1. SLAB ON GRADE ---- 100 PSF

ROOF LOADS:

- I. LIVE LOAD ---- 30 PSF
- 2. GROUND SNOW LOAD, pg ----- 30 PSF 3. FLAT ROOF SNOW LOAD, pf ---- 23 PSF
- 4. SNOW EXPOSURE FACTOR, Ce ---- 1.0 5. SNOW LOAD IMPORTANCE FACTOR, Is ----- 1.1
- 6. THERMAL FACTOR, Ct -----1.0

INSPECTION TABLES

STATEMENT OF SPECIAL INSPECTIONS:


INSPECTION OR TESTING SHALL BE PROVIDED FOR ALL MATERIAL, COMPONENTS AND WORK LISTED IN THE TABLES BELOW.

NOTE 2:

DEFINITIONS:

- a CONTINUOUS INSPECTION: INDICATES SPECIAL INSPECTOR SHALL BE PRESENT DURING CONTRACTOR PERFORMANCE OF THE TASK.
- b PERIODIC INSPECTION: INDICATES SPECIAL INSPECTOR SHALL PROVIDE INSPECTION OR TESTING OF ALL WORK INDICATED, BUT THAT SPECIAL INSPECTOR IS NOT REQUIRED TO BE PRESENT DURING CONTRACTOR PERFORMANCE OF THE TASK, PERIODIC INSPECTION DOES NOT MEAN RANDOM INSPECTION IS ALLOWED.
- c RANDOM INSPECTION: INDICATES SPECIAL INSPECTOR SHALL PROVIDE INSPECTION OR TESTING, AS NEEDED, TO INSURE PROPER PERFORMANCE OF THE TASK BY THE CONTRACTOR.

CONCRETE				
INSPECTION TASK	TYPE OF INSPECTION			
INSPECTION OF REINFORCING STEEL FOR SIZE, QUANTITY AND PLACEMENT.	PERIODIC			
2. INSPECTION OF ANCHORS CAST IN CONCRETE.	PERIODIC			
3. INSPECTION OF ANCHORS POST-INSTALLED IN HARDENED CONCRETE MEMBERS (FOLLOW MANUFACTURERS WRITTEN INSTALLATION REQUIREMENTS).				
A. ADHESIVE ANCHORS INSTALLED IN HORIZONTAL OR UPWARDLY INCLINED ORIENTATIONS	A. CONTINUOUS			
B. ALL OTHER CONDITIONS	B. PERIODIC			
4. VERIFY USE OF REQUIRED DESIGN MIX.	PERIODIC			
5. AT THE TIME FRESH CONCRETE IS SAMPLED TO FABRICATE SPECIMENS FOR STRENGTH TESTS, PERFORM SLUMP AND AIR CONTENT TESTS, AND DETERMINE THE TEMPERATURE OF THE CONCRETE. FOR LIGHTWEIGHT CONCRETE, PERFORM UNIT WEIGHT TESTS.	CONTINUOUS			
6. INSPECTION OF CONCRETE PLACEMENT.	CONTINUOUS			
7. INSPECTION FOR MAINTENANCE OF SPECIFIED CURING TEMPERATURE AND TECHNIQUES.	PERIODIC			
8. VERIFICATION OF IN-SITU CONCRETE STRENGTH, PRIOR TO REMOVAL OF SHORES AND FORMS FROM BEAMS AND STRUCTURAL SLABS.	PERIODIC			
9. INSPECT FORMWORK FOR SHAPE, LOCATION AND DIMENSIONS OF THE CONCRETE MEMBER BEING FORMED AND FOR CONFORMANCE WITH FORMWORK DESIGN.	PERIODIC			
10. MEASURE F (F) AND F (L) TOLERANCE FOR FLOORS.	PERIODIC			

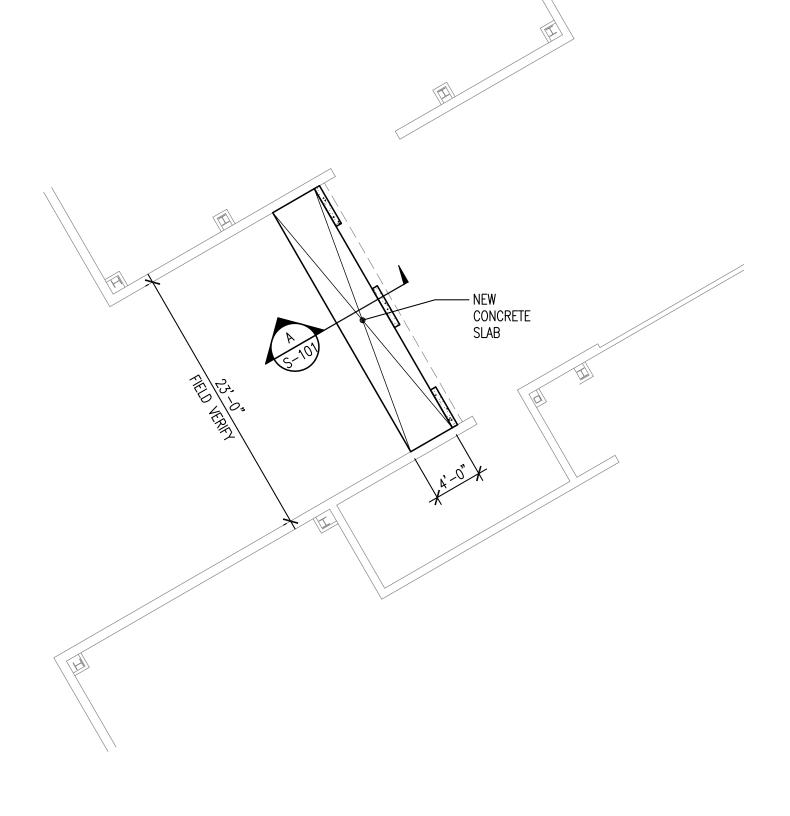


PARTIAL ENTRY VESTIBULE PLAN

SCALE: 1/8"=1'-0"

SECTION

SCALE: 1"=1'-0"

1. CONCRETE SLAB SHALL BE 4" THICK NORMAL WEIGHT CONCRETE (f'c=5000 PSI) AIR ENTRAINED CONCRETE REINFORCED WITH 6"x6". W1.4xW1.4 WWF OVER 4" THICK LAYER OF COARSE COMPACTED GRANULAR FILL.

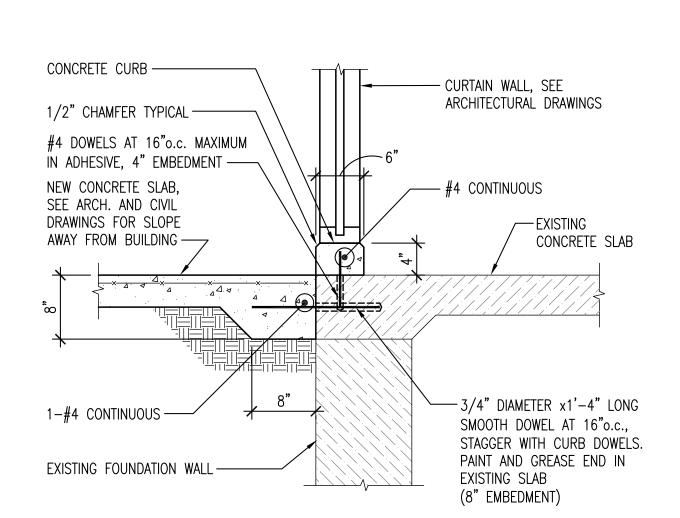

S-101



CONSULTANTS

SEAL





DESIGN AND CONSTRUCTION

DIVISION

REVISIONS NO. DATE DESCRIPTION **BID DOCUMENTS**

PLAN, GENERAL NOTES, TYPICAL DETAIL AND SECTION



Columbia Engineering Inc. Structural Engineers

BID DOCUMENTS

6210 Old Dobbin Lane Tel 410.992.9970 Fax 410.992.0627 Columbia, Maryland 21045 opyright © 2020 Columbia Engineering. All rights reserved ofessional Certification: I hereby certify that these documents were prepared or

approved by me, and that I am a duly licensed professional engineer under the laws of the State of Maryland, License No. 21136, Expiration Date: 07/31/2023.

columbiaengineering.cor

SHEET

6/10/22

30 **□F** 30